
# CITY OF SEBASTOPOL CONTRACT NO. 2025-02

# BODEGA AVENUE BIKE LANES AND REHABILITATION PHASE 2

# REHABILITATION OF CORRIDOR IN THE CITY OF SEBASTOPOL

SUPPLEMENTED BY CITY OF SEBASTOPOL DETAILS AND 2024 STATE STANDARD PLANS

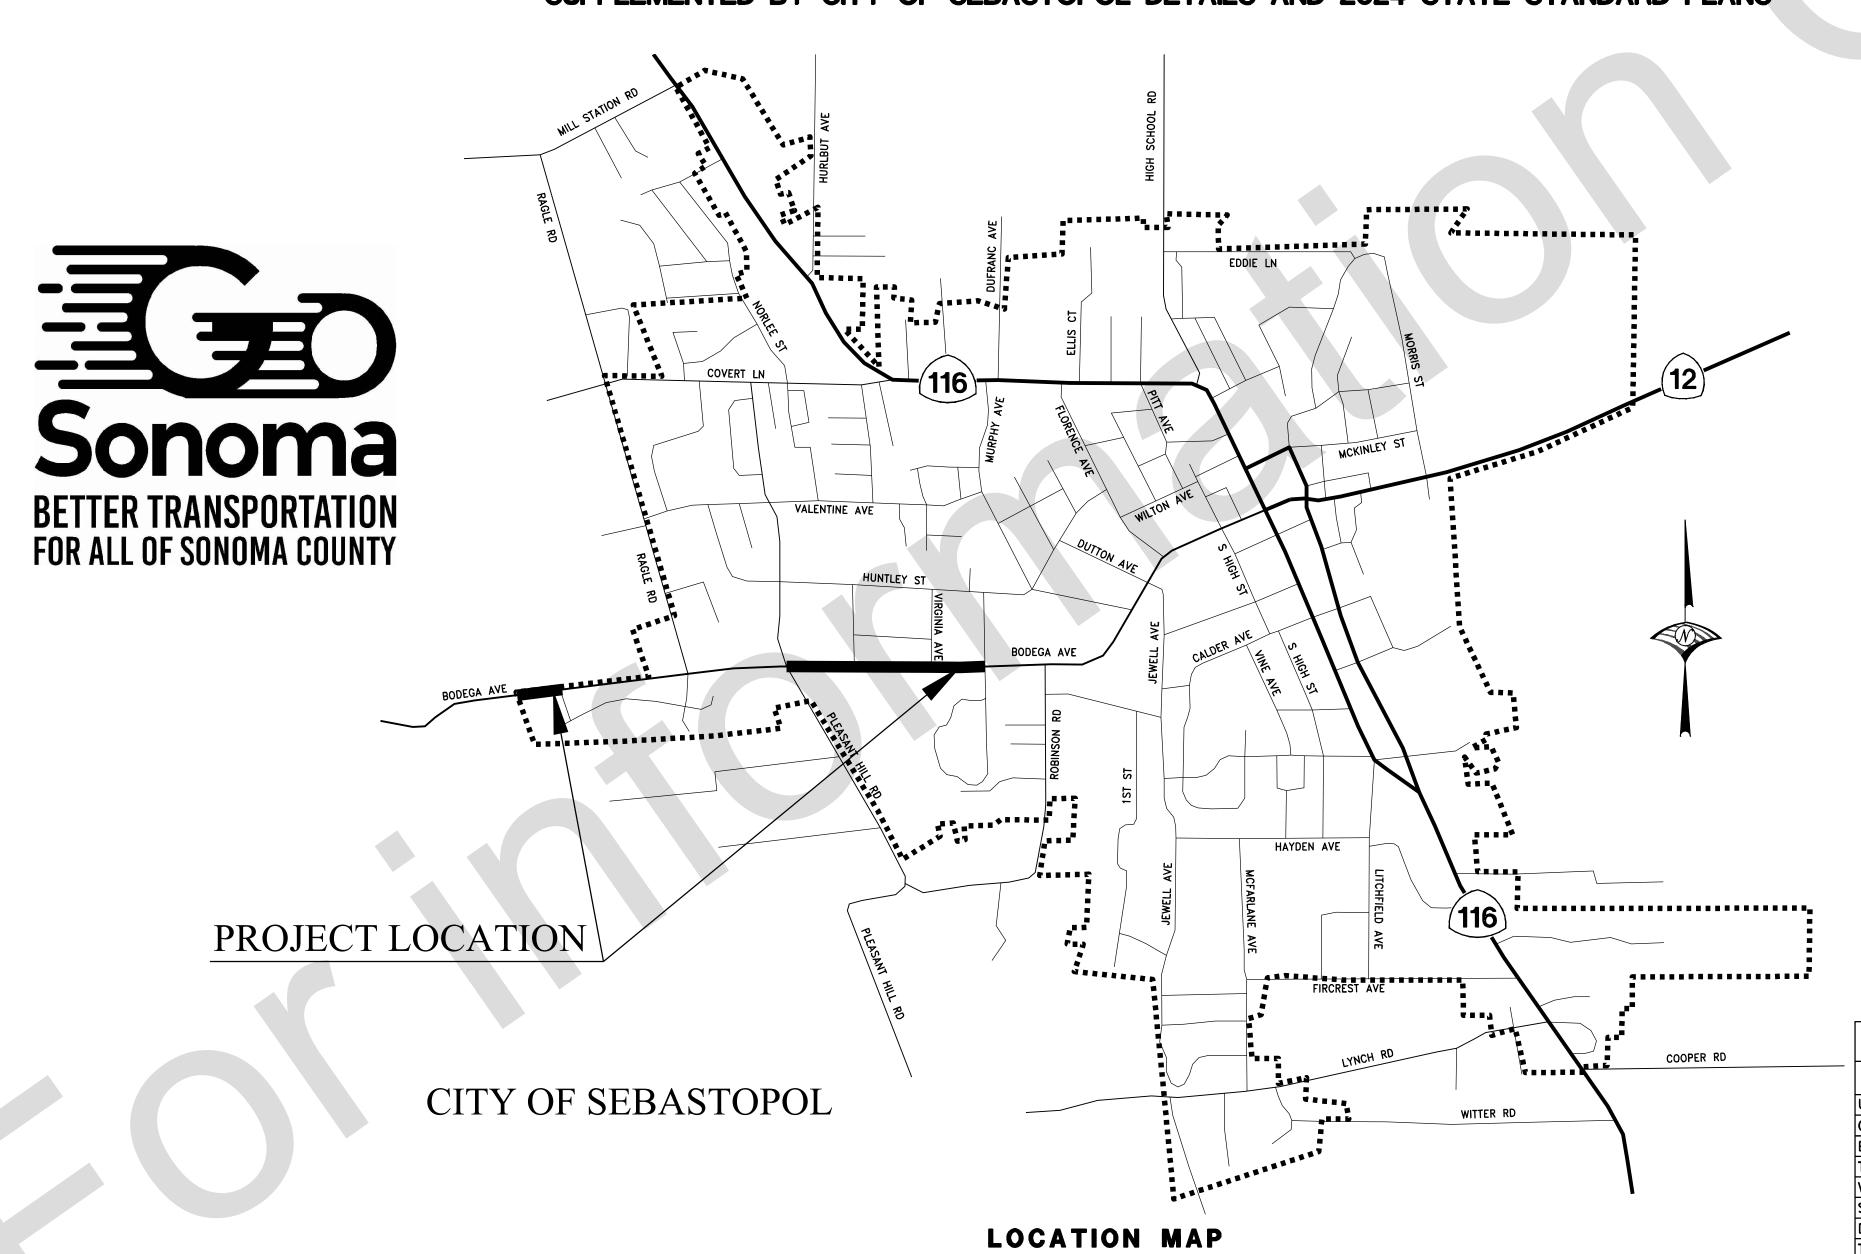

#### INDEX OF SHEETS

TITLE SHEET TYPICAL SECTIONS PLAN AND PROFILE CONSTRUCTION DETAILS SIGNING AND STRIPING SIGN QUANTITIES PROJECT CONTROL TRAFFIC HANDLING

RETAINING WALL LAYOUT

PAVEMENT REHABILITATION NEAR ATASCADERO CREEK BRIDGE



#### **LEGEND**

	EXI	<u>ISTING</u>	
OVERHEAD ELECTRICAL	————-е		)-
UNDERGROUND ELECTRICAL	e		_
OVERHEAD TELEPHONE			_
UNDERGROUND TELEPHONE	<u></u>		_
NATURAL GAS		g	_
SEWER	s		-
WATER	w	w -	_
STORM DRAIN	sd	sd	_

UTILITY REPRESENTATIVES					
UTILITY	REPRESENT	PHONE			
U.S.A.			1-800-227-2600		
GAS	PG&E	STEVE WILLIS	(707) 579-6300		
ELECTRICITY	PG&E	STEVE WILLIS	(707) 579-6300		
TELEPHONE	AT&T	MICHAEL MCAFFEE	(415) 233-1474		
WATER	CITY OF SEBASTOPOL	ERIK BILLING	(707) 823-5331		
SEWER	CITY OF SEBASTOPOL	ERIK BILLING	(707) 823-5331		
DRAINAGE	CITY OF SEBASTOPOL	ERIK BILLING	(707) 823-5331		
T.V. CABLE	COMCAST	TONYA BATTLE	(925) 453-6556		
BROADBAND FIBER OPTIC	SONIC	HANK SCHLOTMAN	(707) 522-1000 EXT. 2542		

WOOD RODGERS GACRAMENTO, CA 95816 FAX 916.341.7767

**ABBREVIATIONS** 

BEGIN

BEGIN CURVE BACK OF WALK

CENTERLINE DRAINAGE INLE

DIMENSION

EAST, EASTING END CURVE

EDGE OF DECK

**EXISTING** 

ELEVATION

FLOW LINE

GRADE BREAK

LENGTH

MANHOLE

MINIMUM

**RADIUS** 

SLOPE **SAWCUT** 

**SIDEWALK** 

STATION STANDARD

RIGHT OF WAY

SOUTH, SEWER

SANITARY SEWER

TOP BACK OF CURB

STRAP AND SADDLE BRACKET METHOD

TEMPORARY CONSTRUCTION EASEMENT

TWO-WAY LEFT-TURN LANE

NORTH, NORTHING

PACIFIC GAS AND ELECTRIC

REINFORCED CONCRETE PIPE

NOT TO SCALE

LINEAR FEET

**EDGE OF PAVEMENT** 

FINISHED SURFACE

HOT MIX ASPHALT

DETECTABLE WARNING SURFACE

AGGREGATE BASE

AMERICAN TELEPHONE AND TELEGRAPH, INC.

PUBLIC WORKS DEPARTMENT SEBASTOPOL CALIFORNIA


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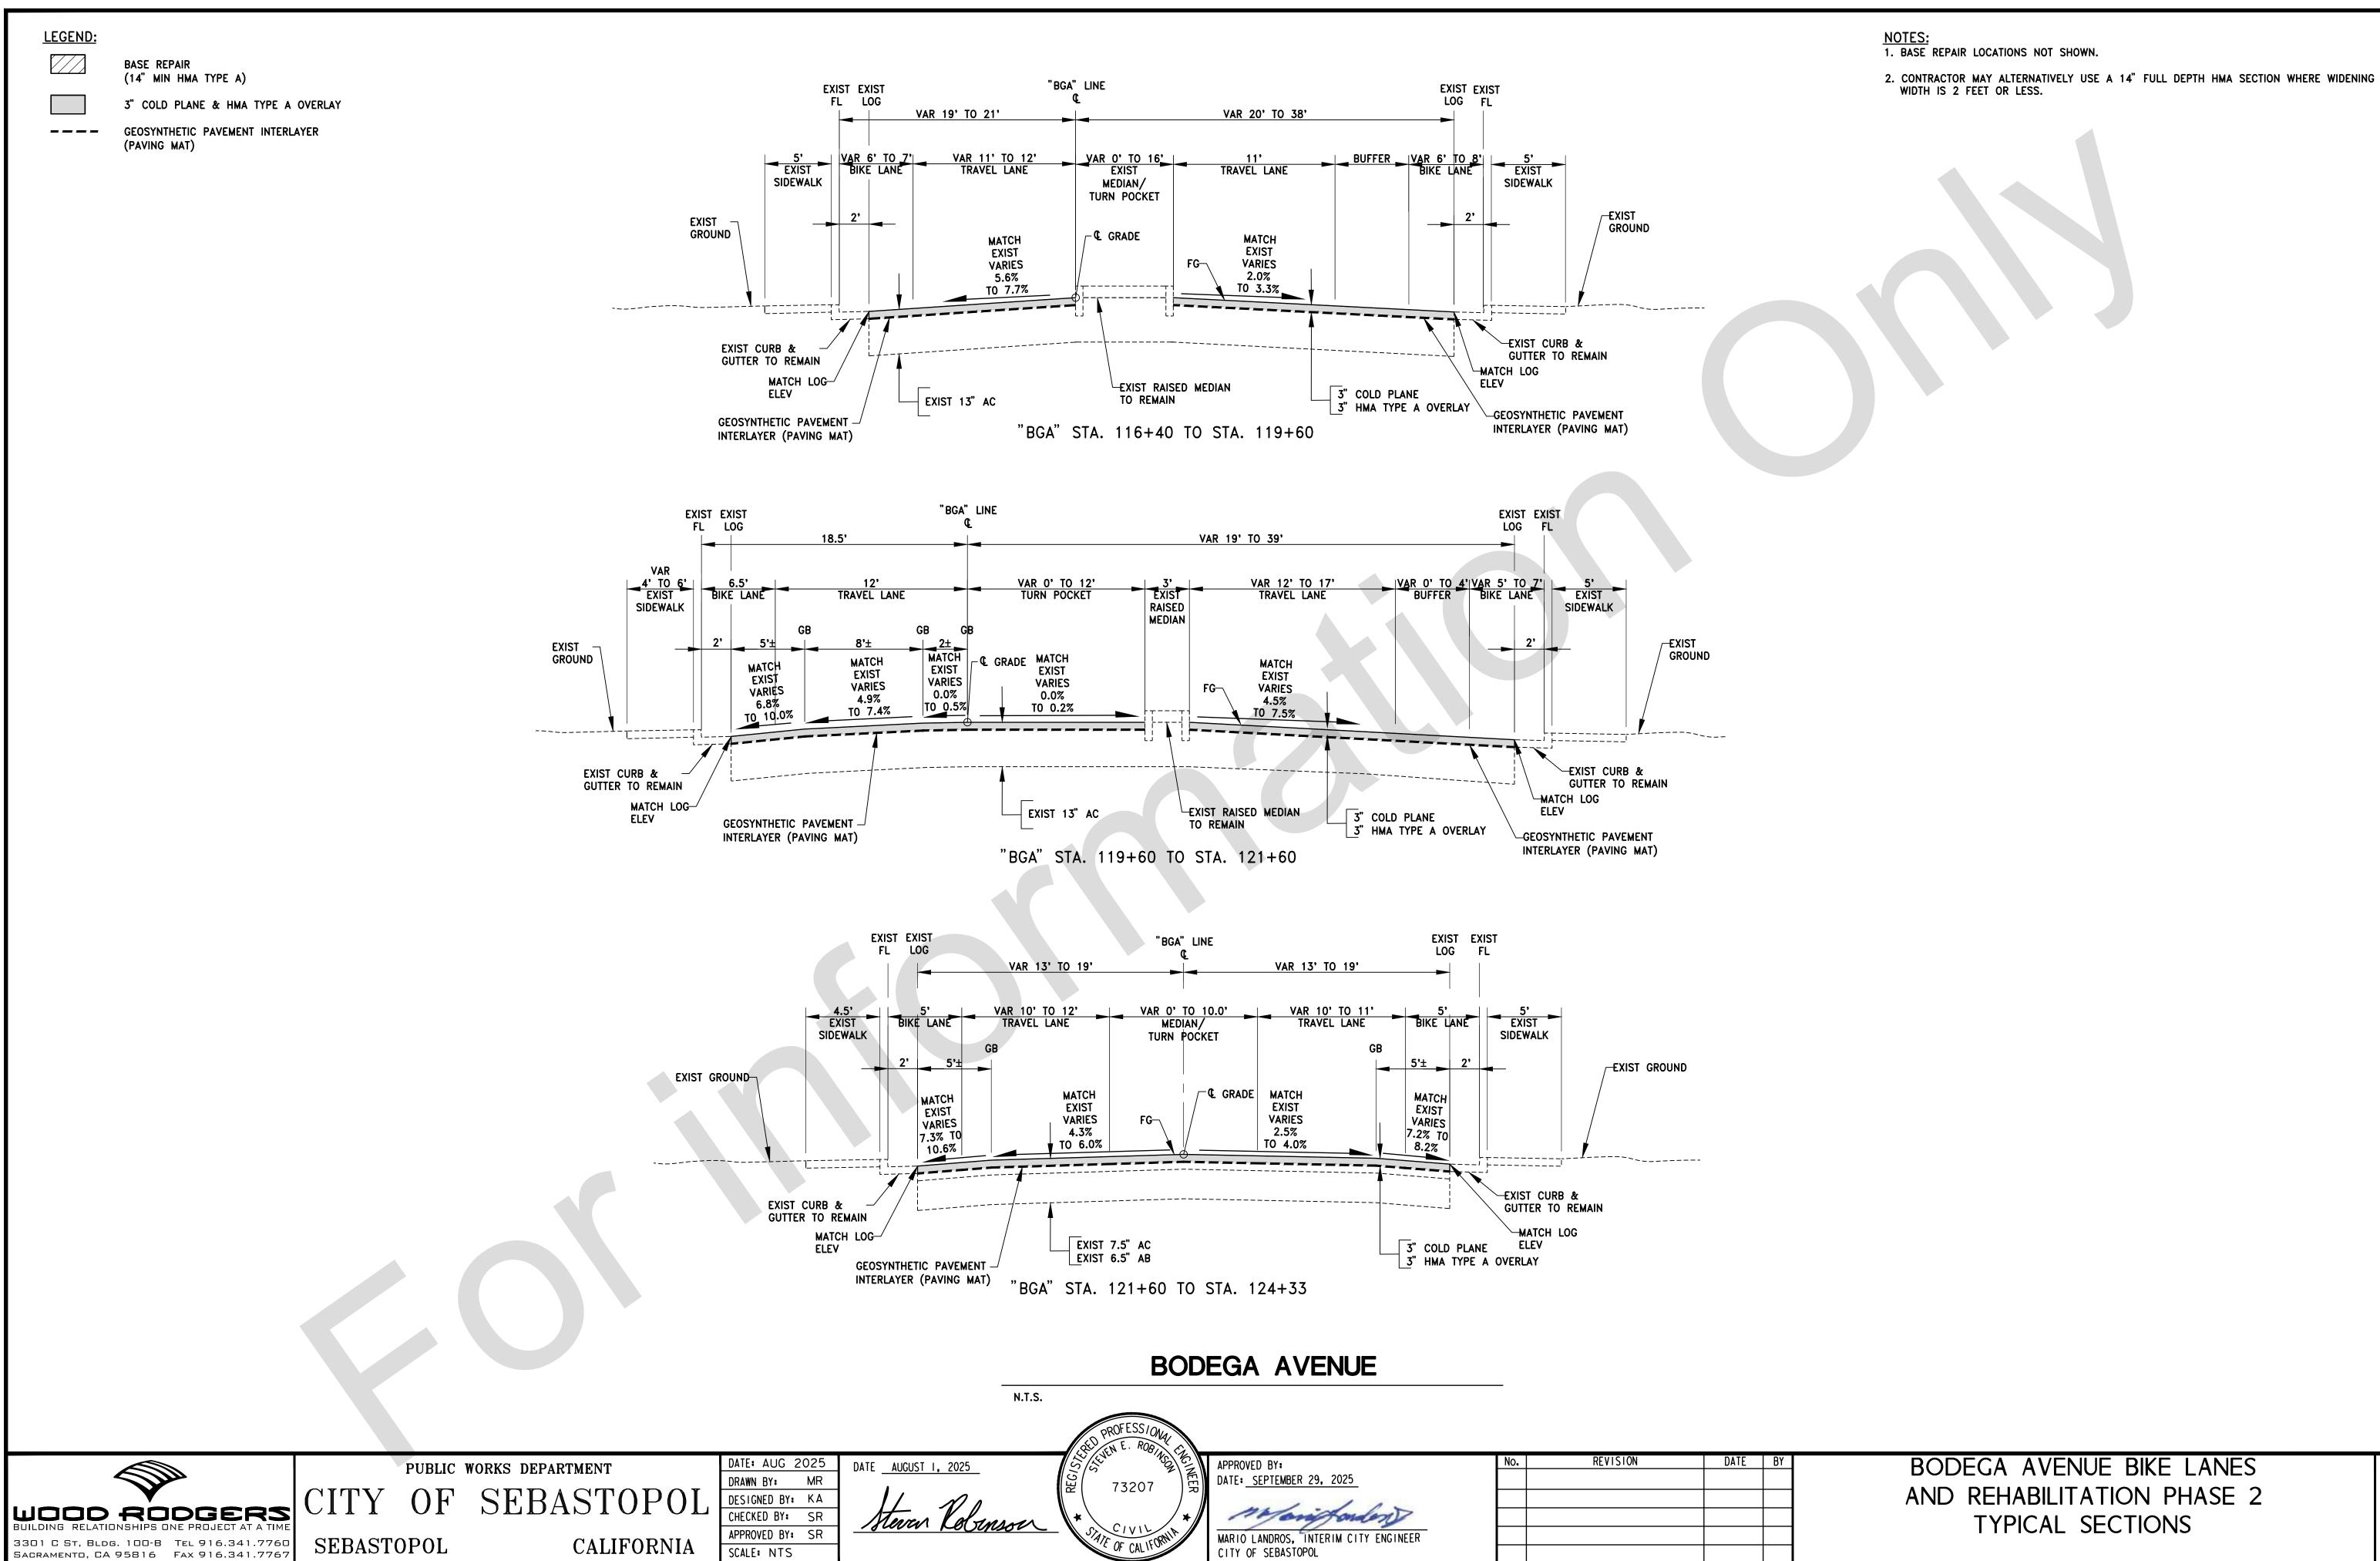
Steven Kolenson




REVISION DATE: SEPTEMBER 29, 2025 MARIO LANDROS, INTERIM CITY ENGINEER


BODEGA AVENUE BIKE LANES AND REHABILITATION PHASE 2 TITLE SHEET




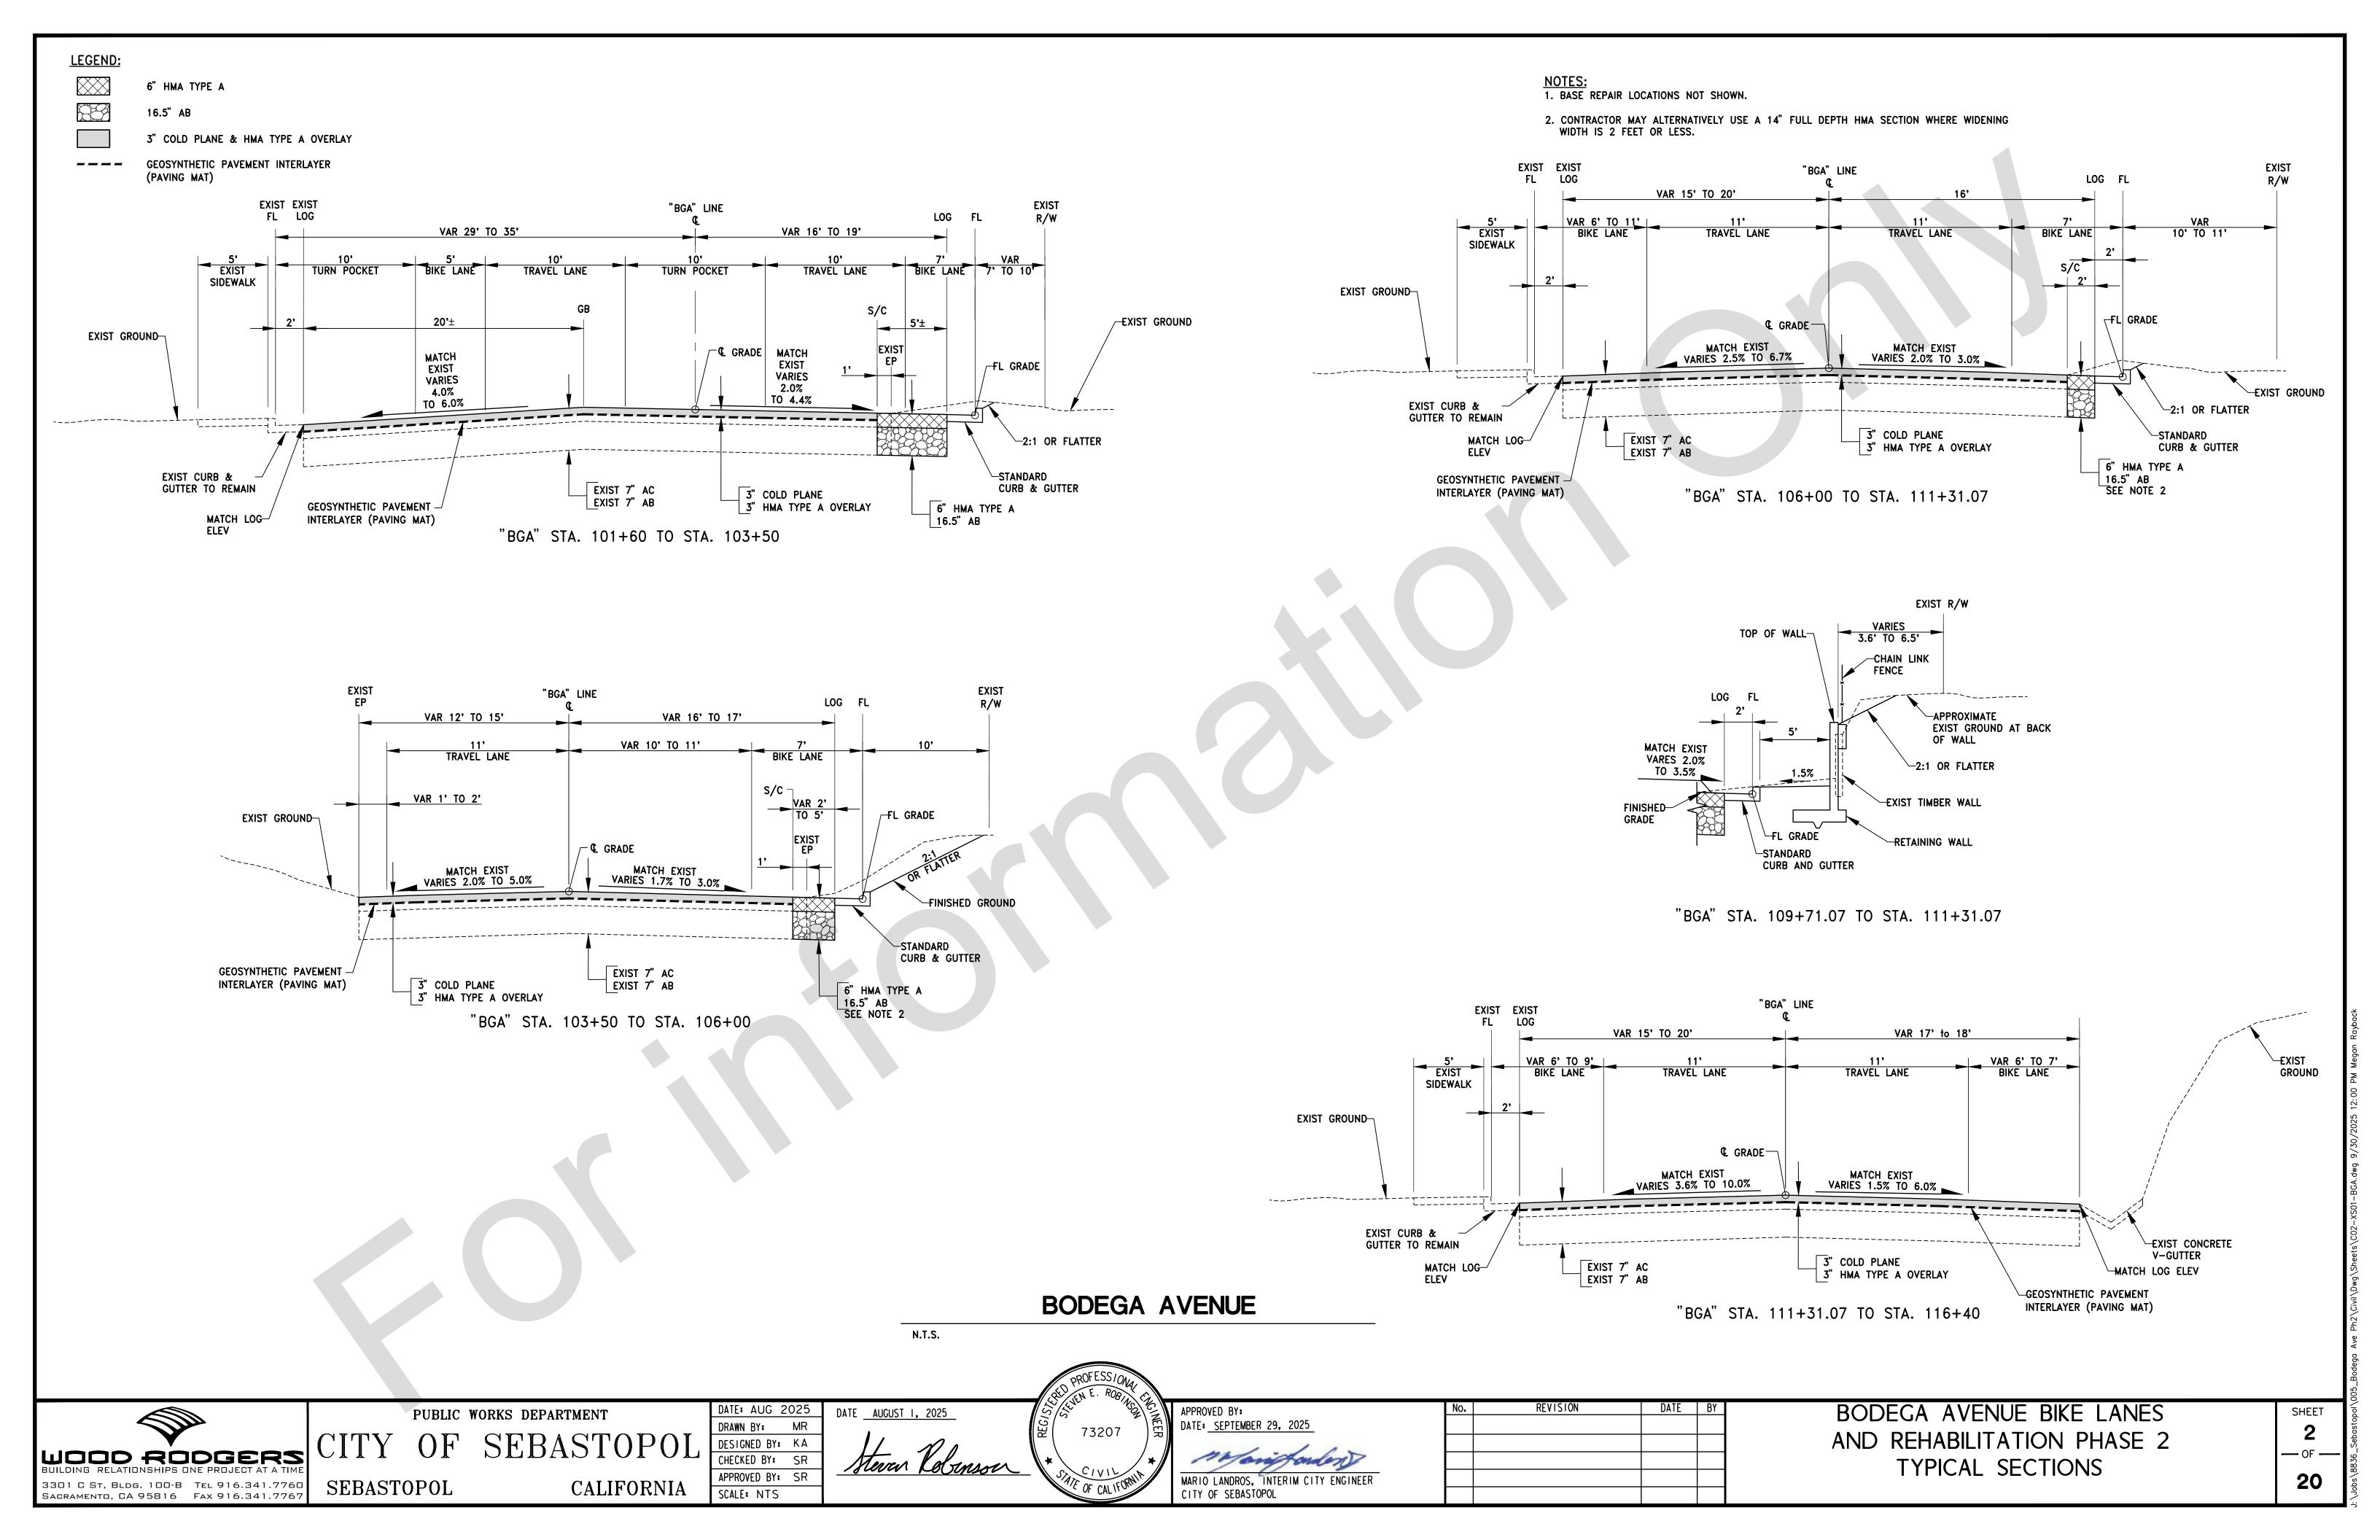



SCALE: NTS

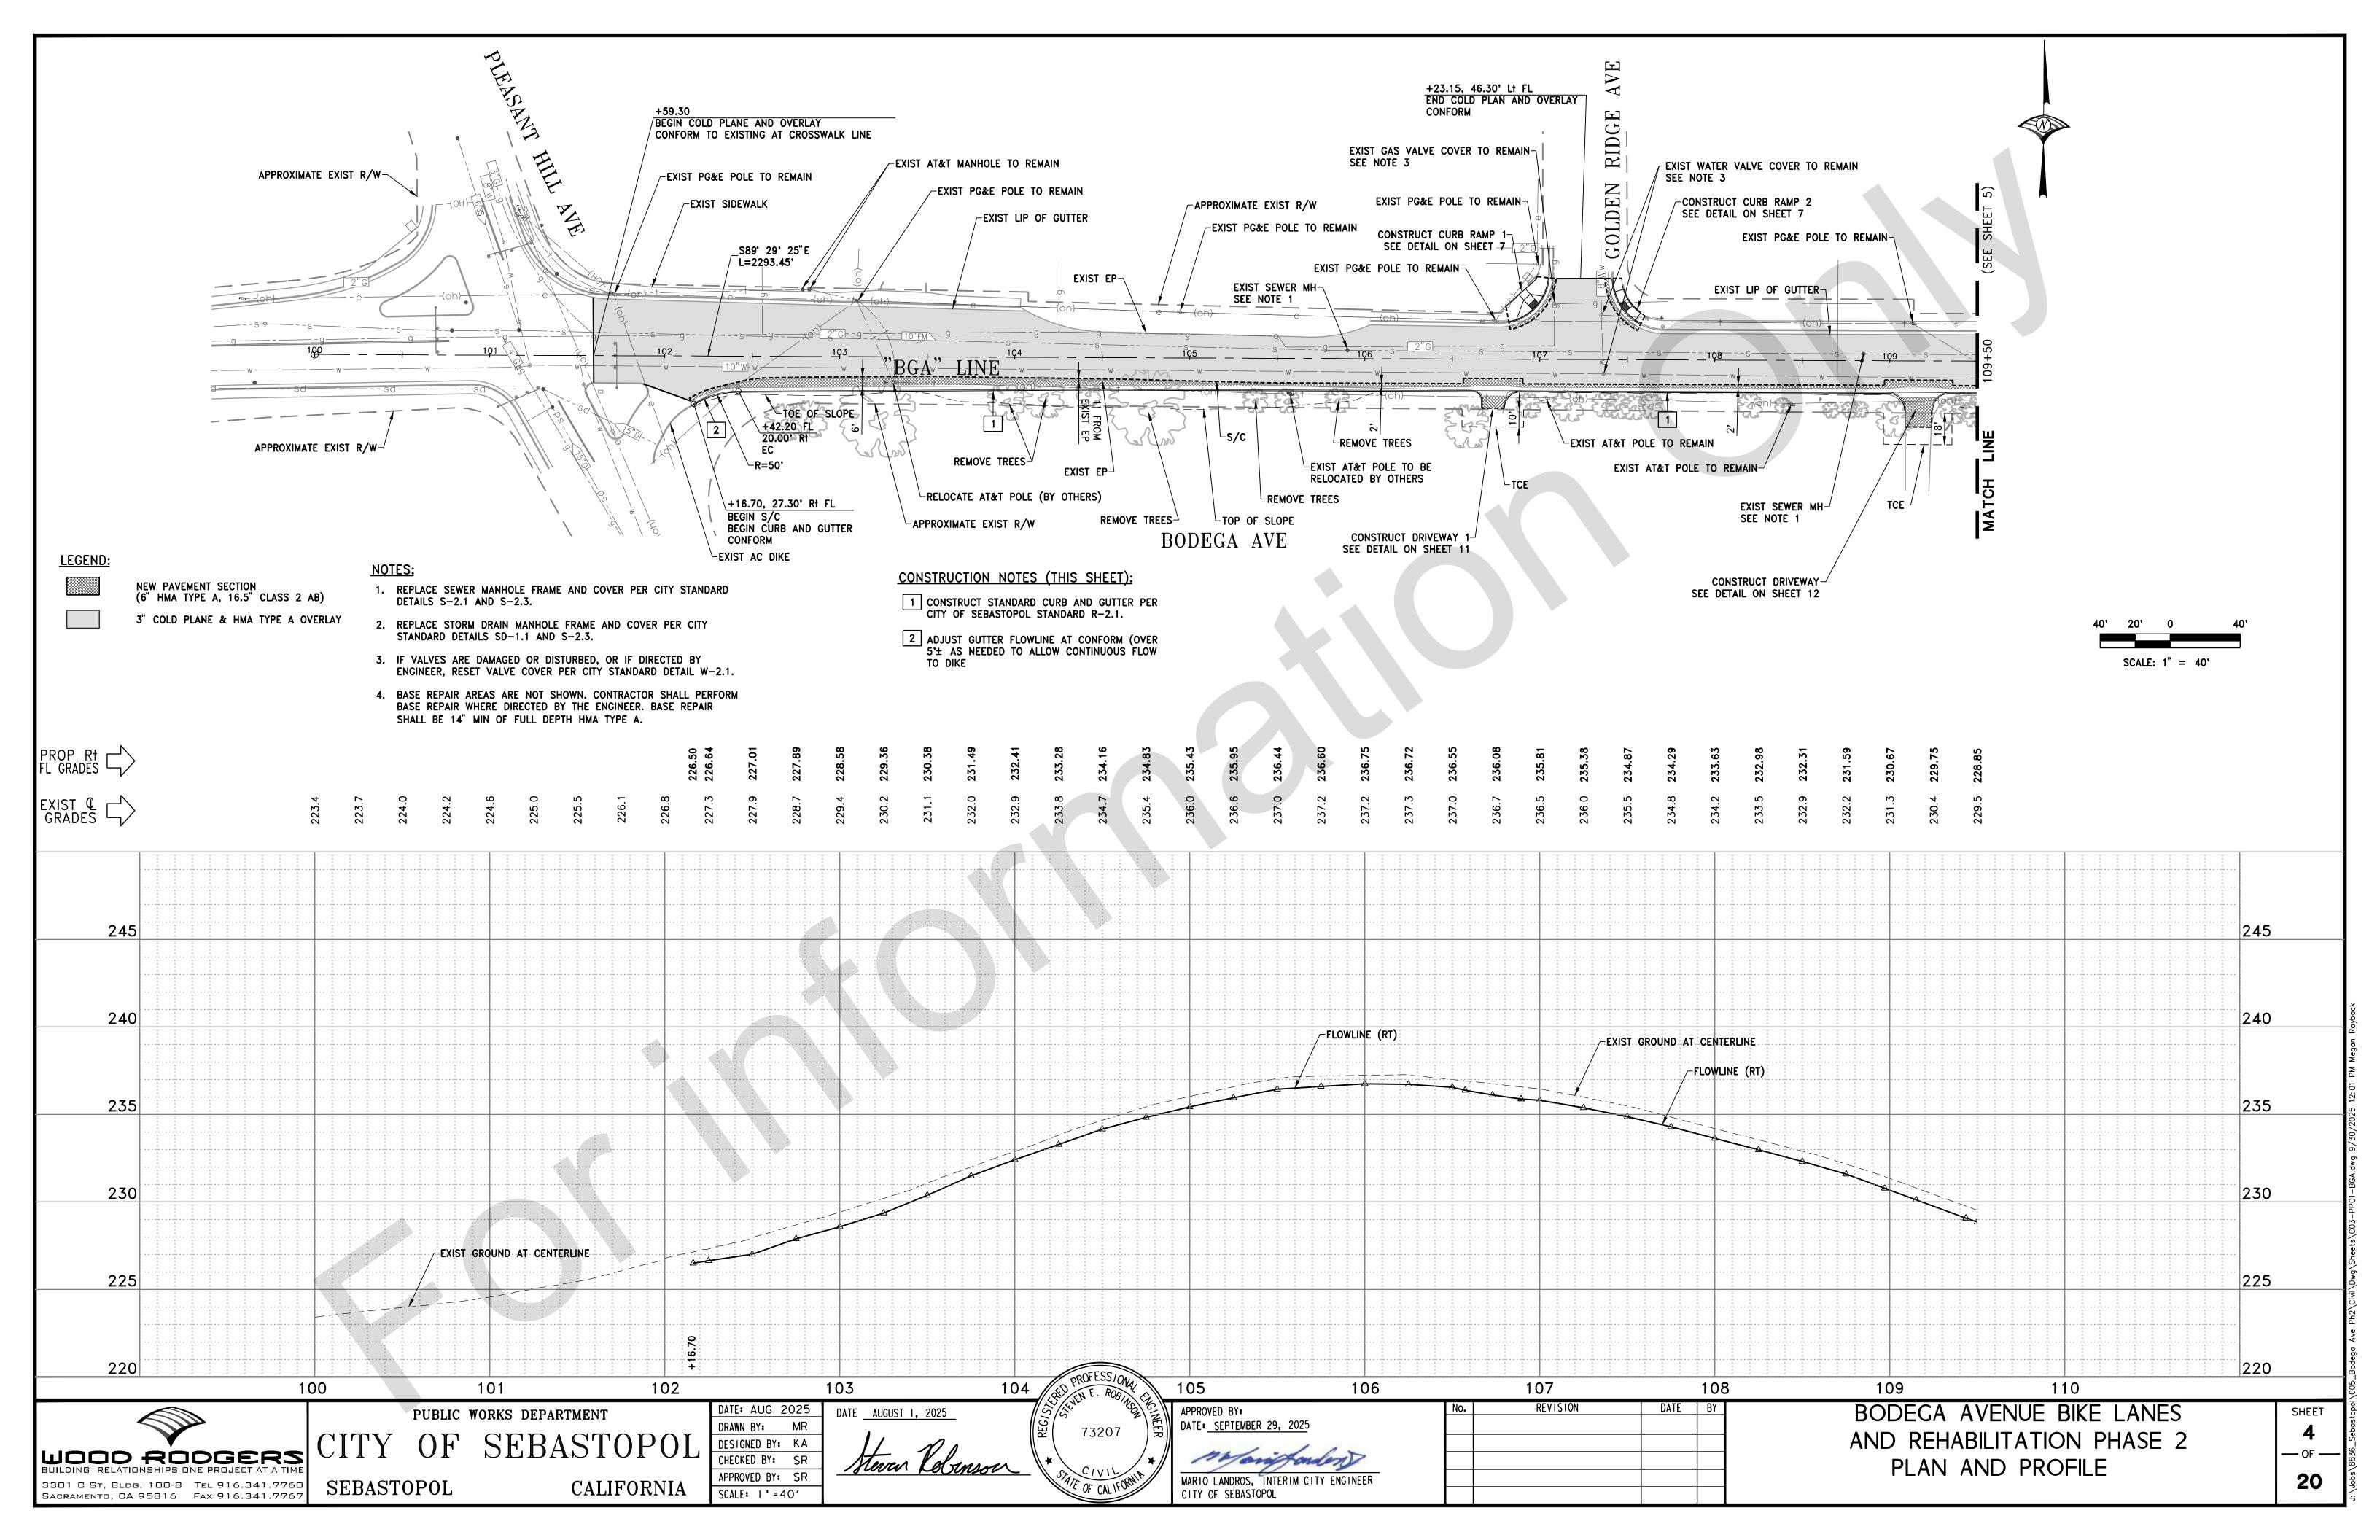


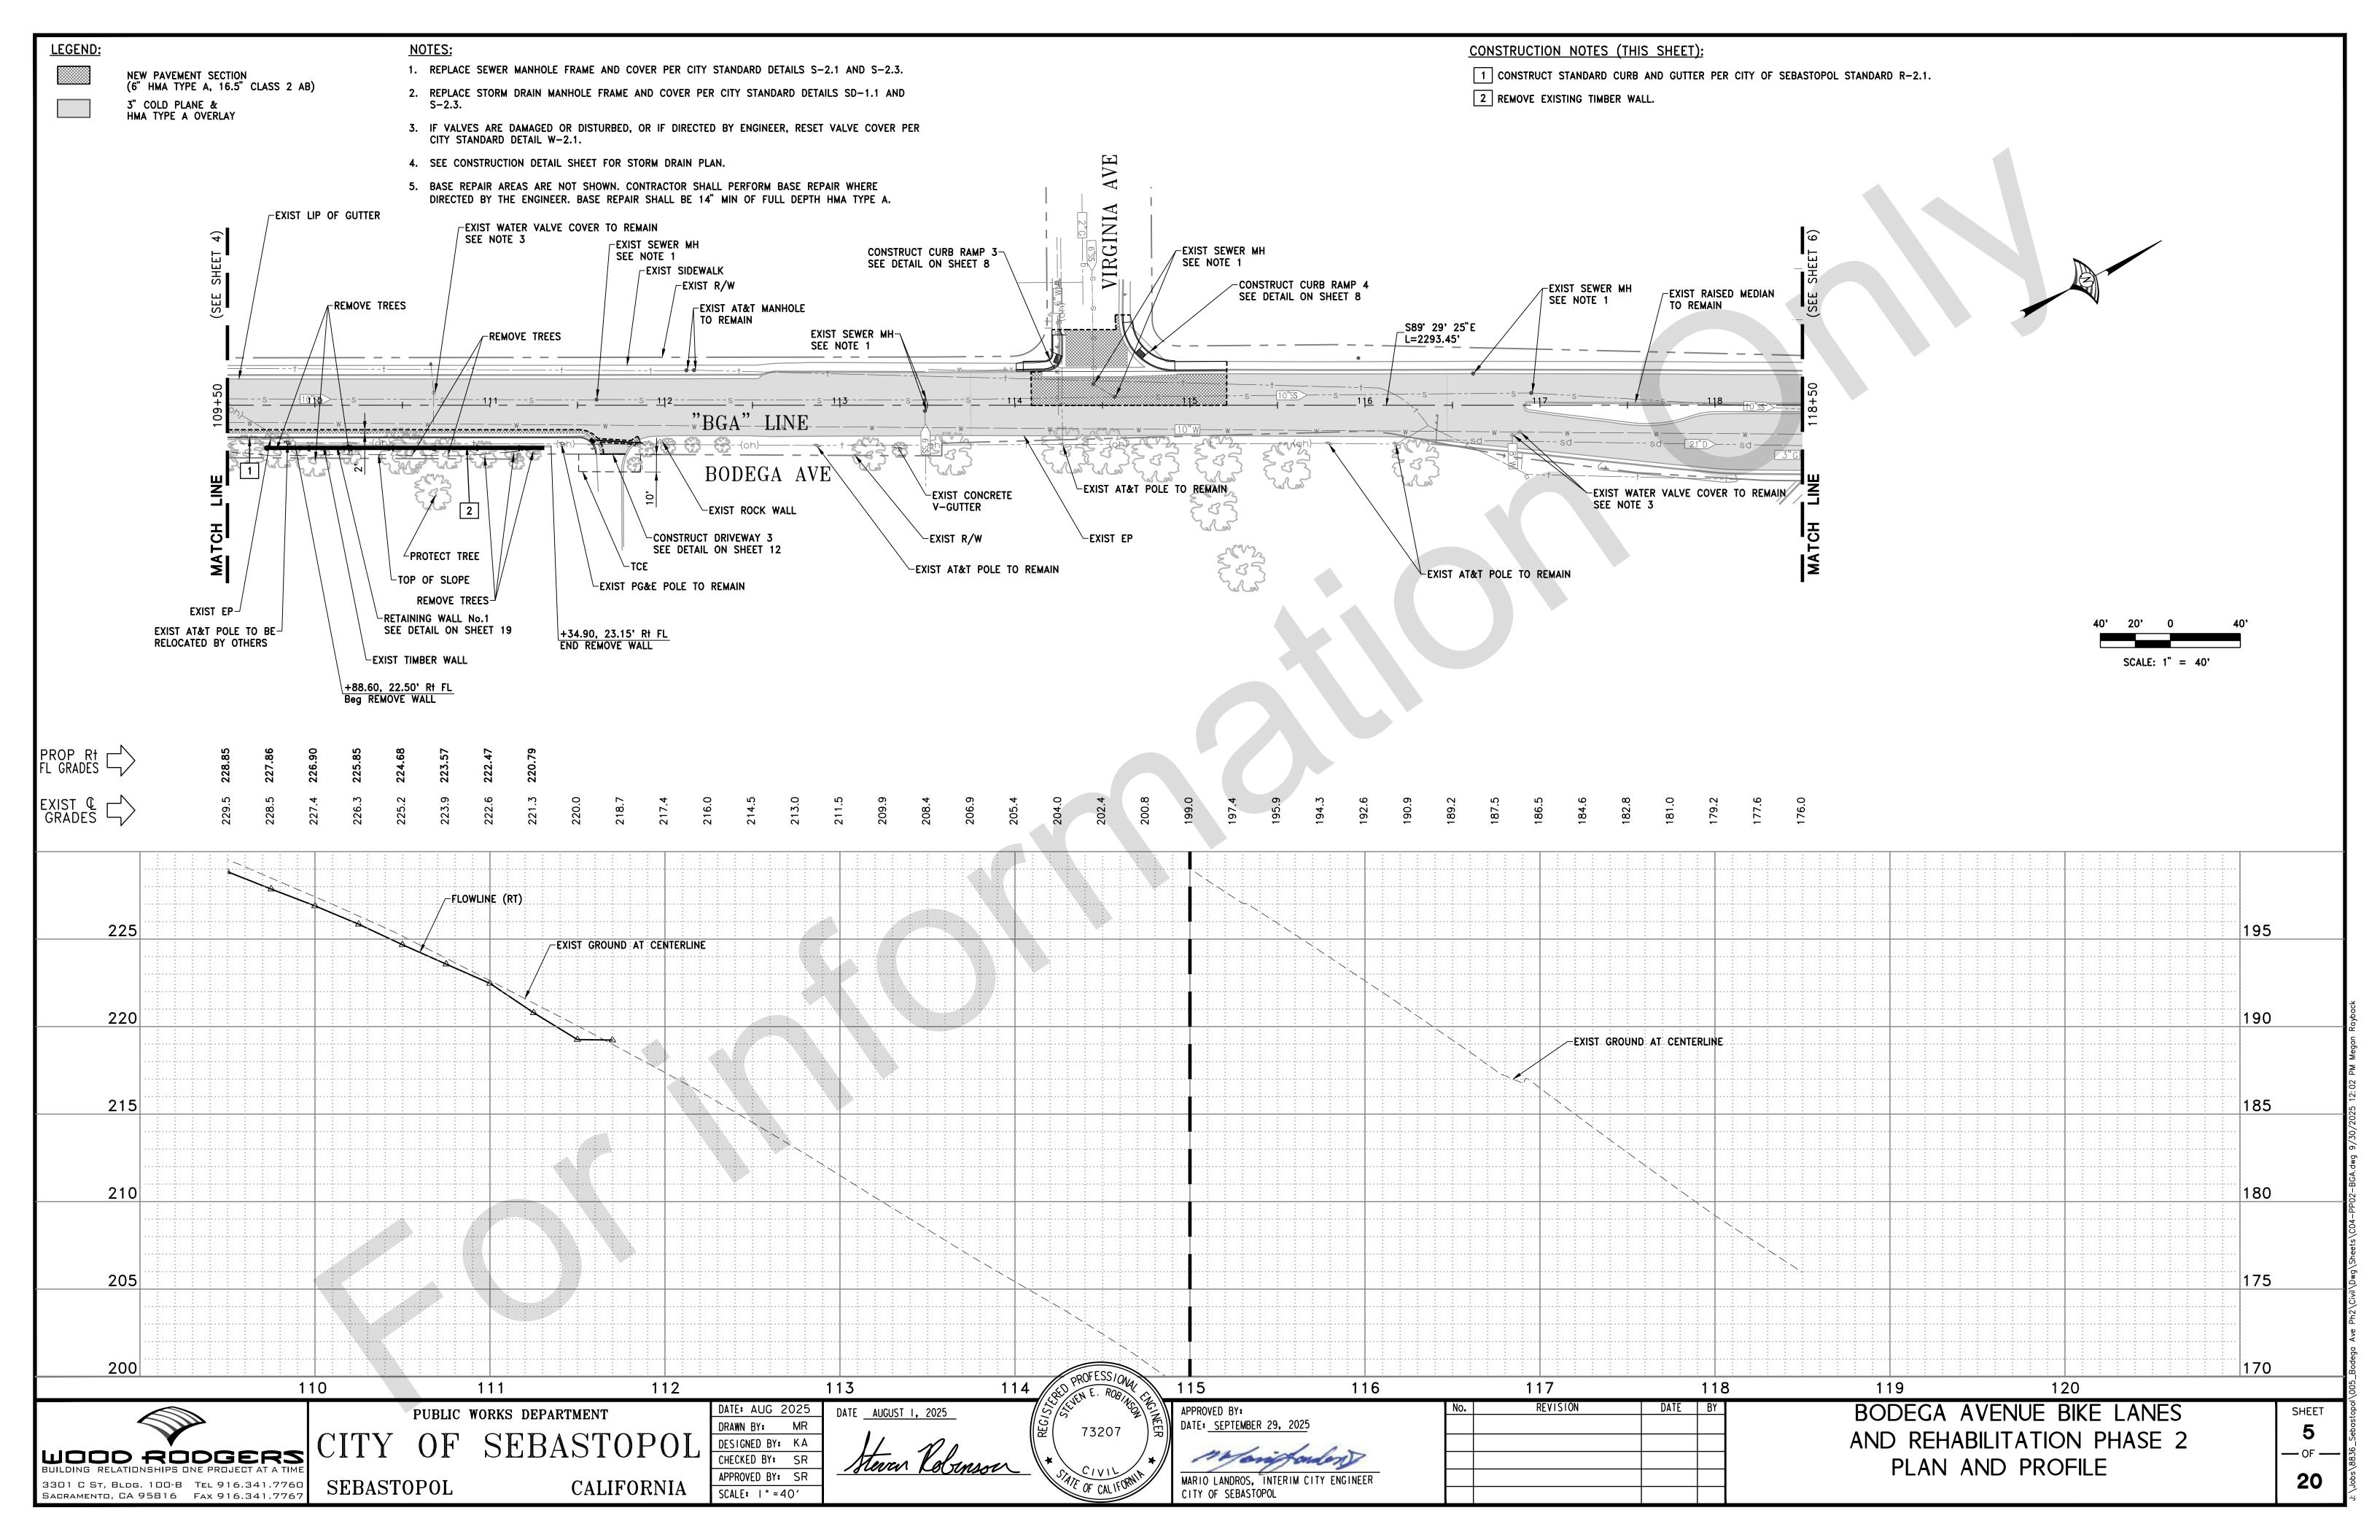


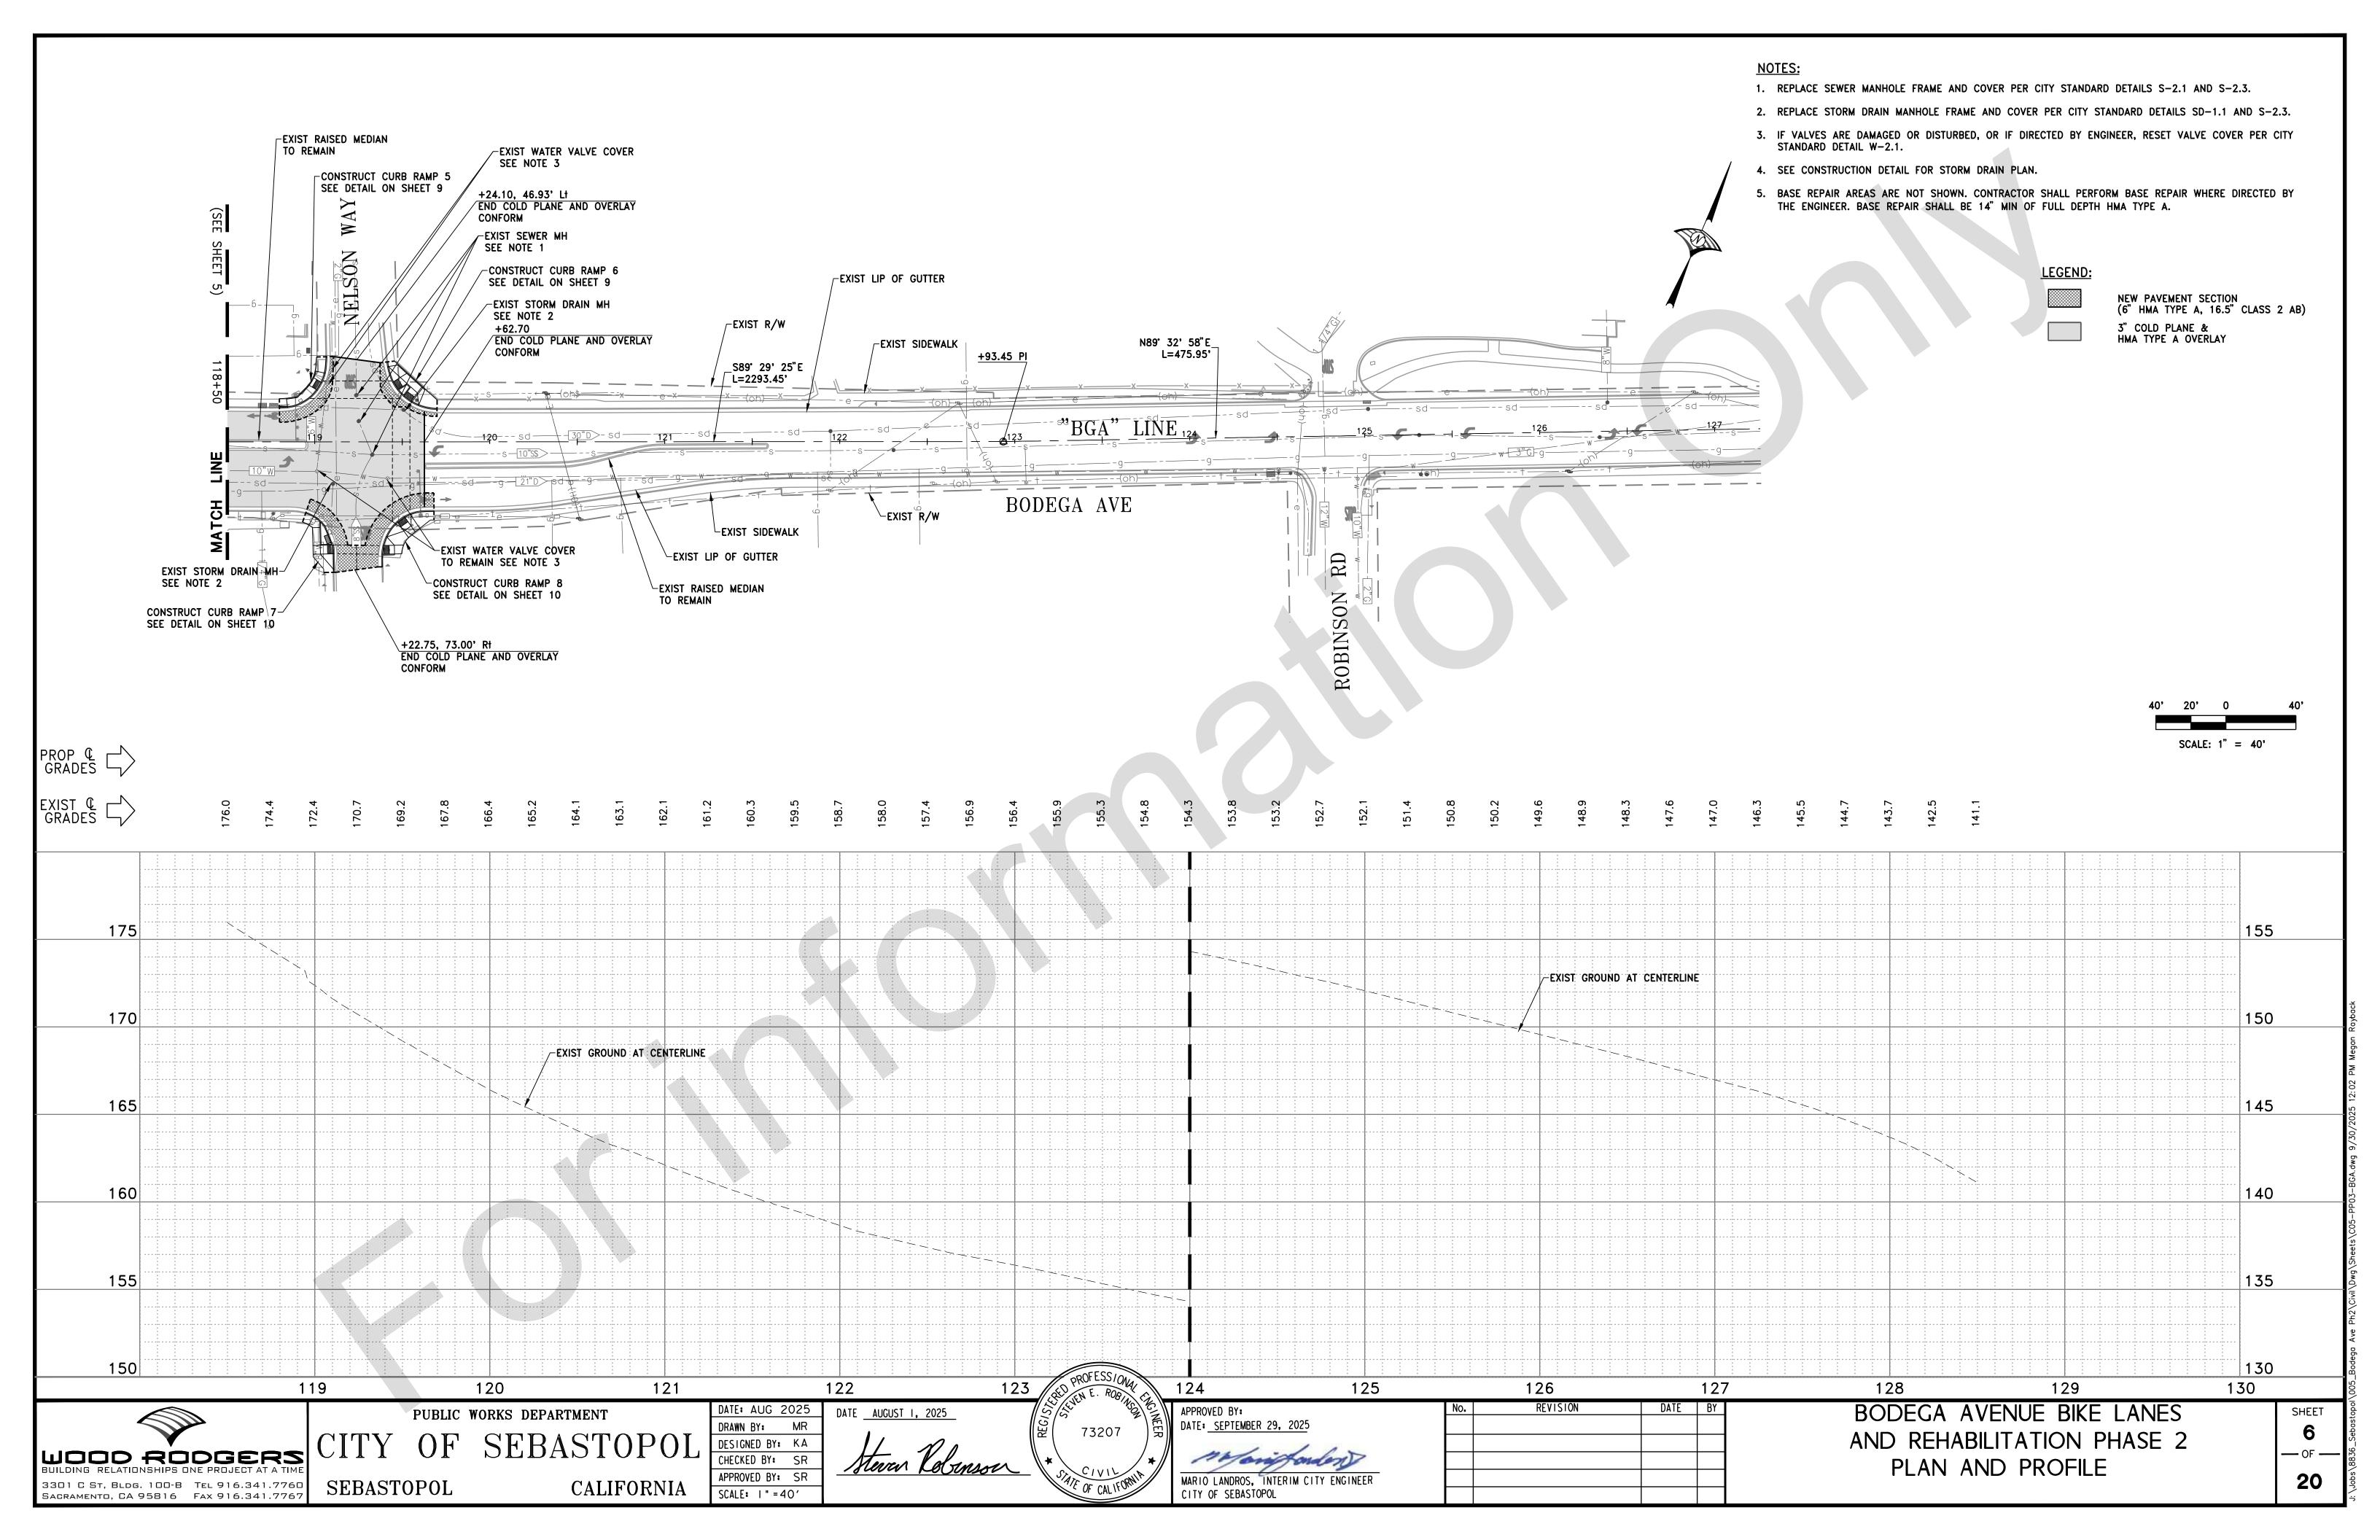

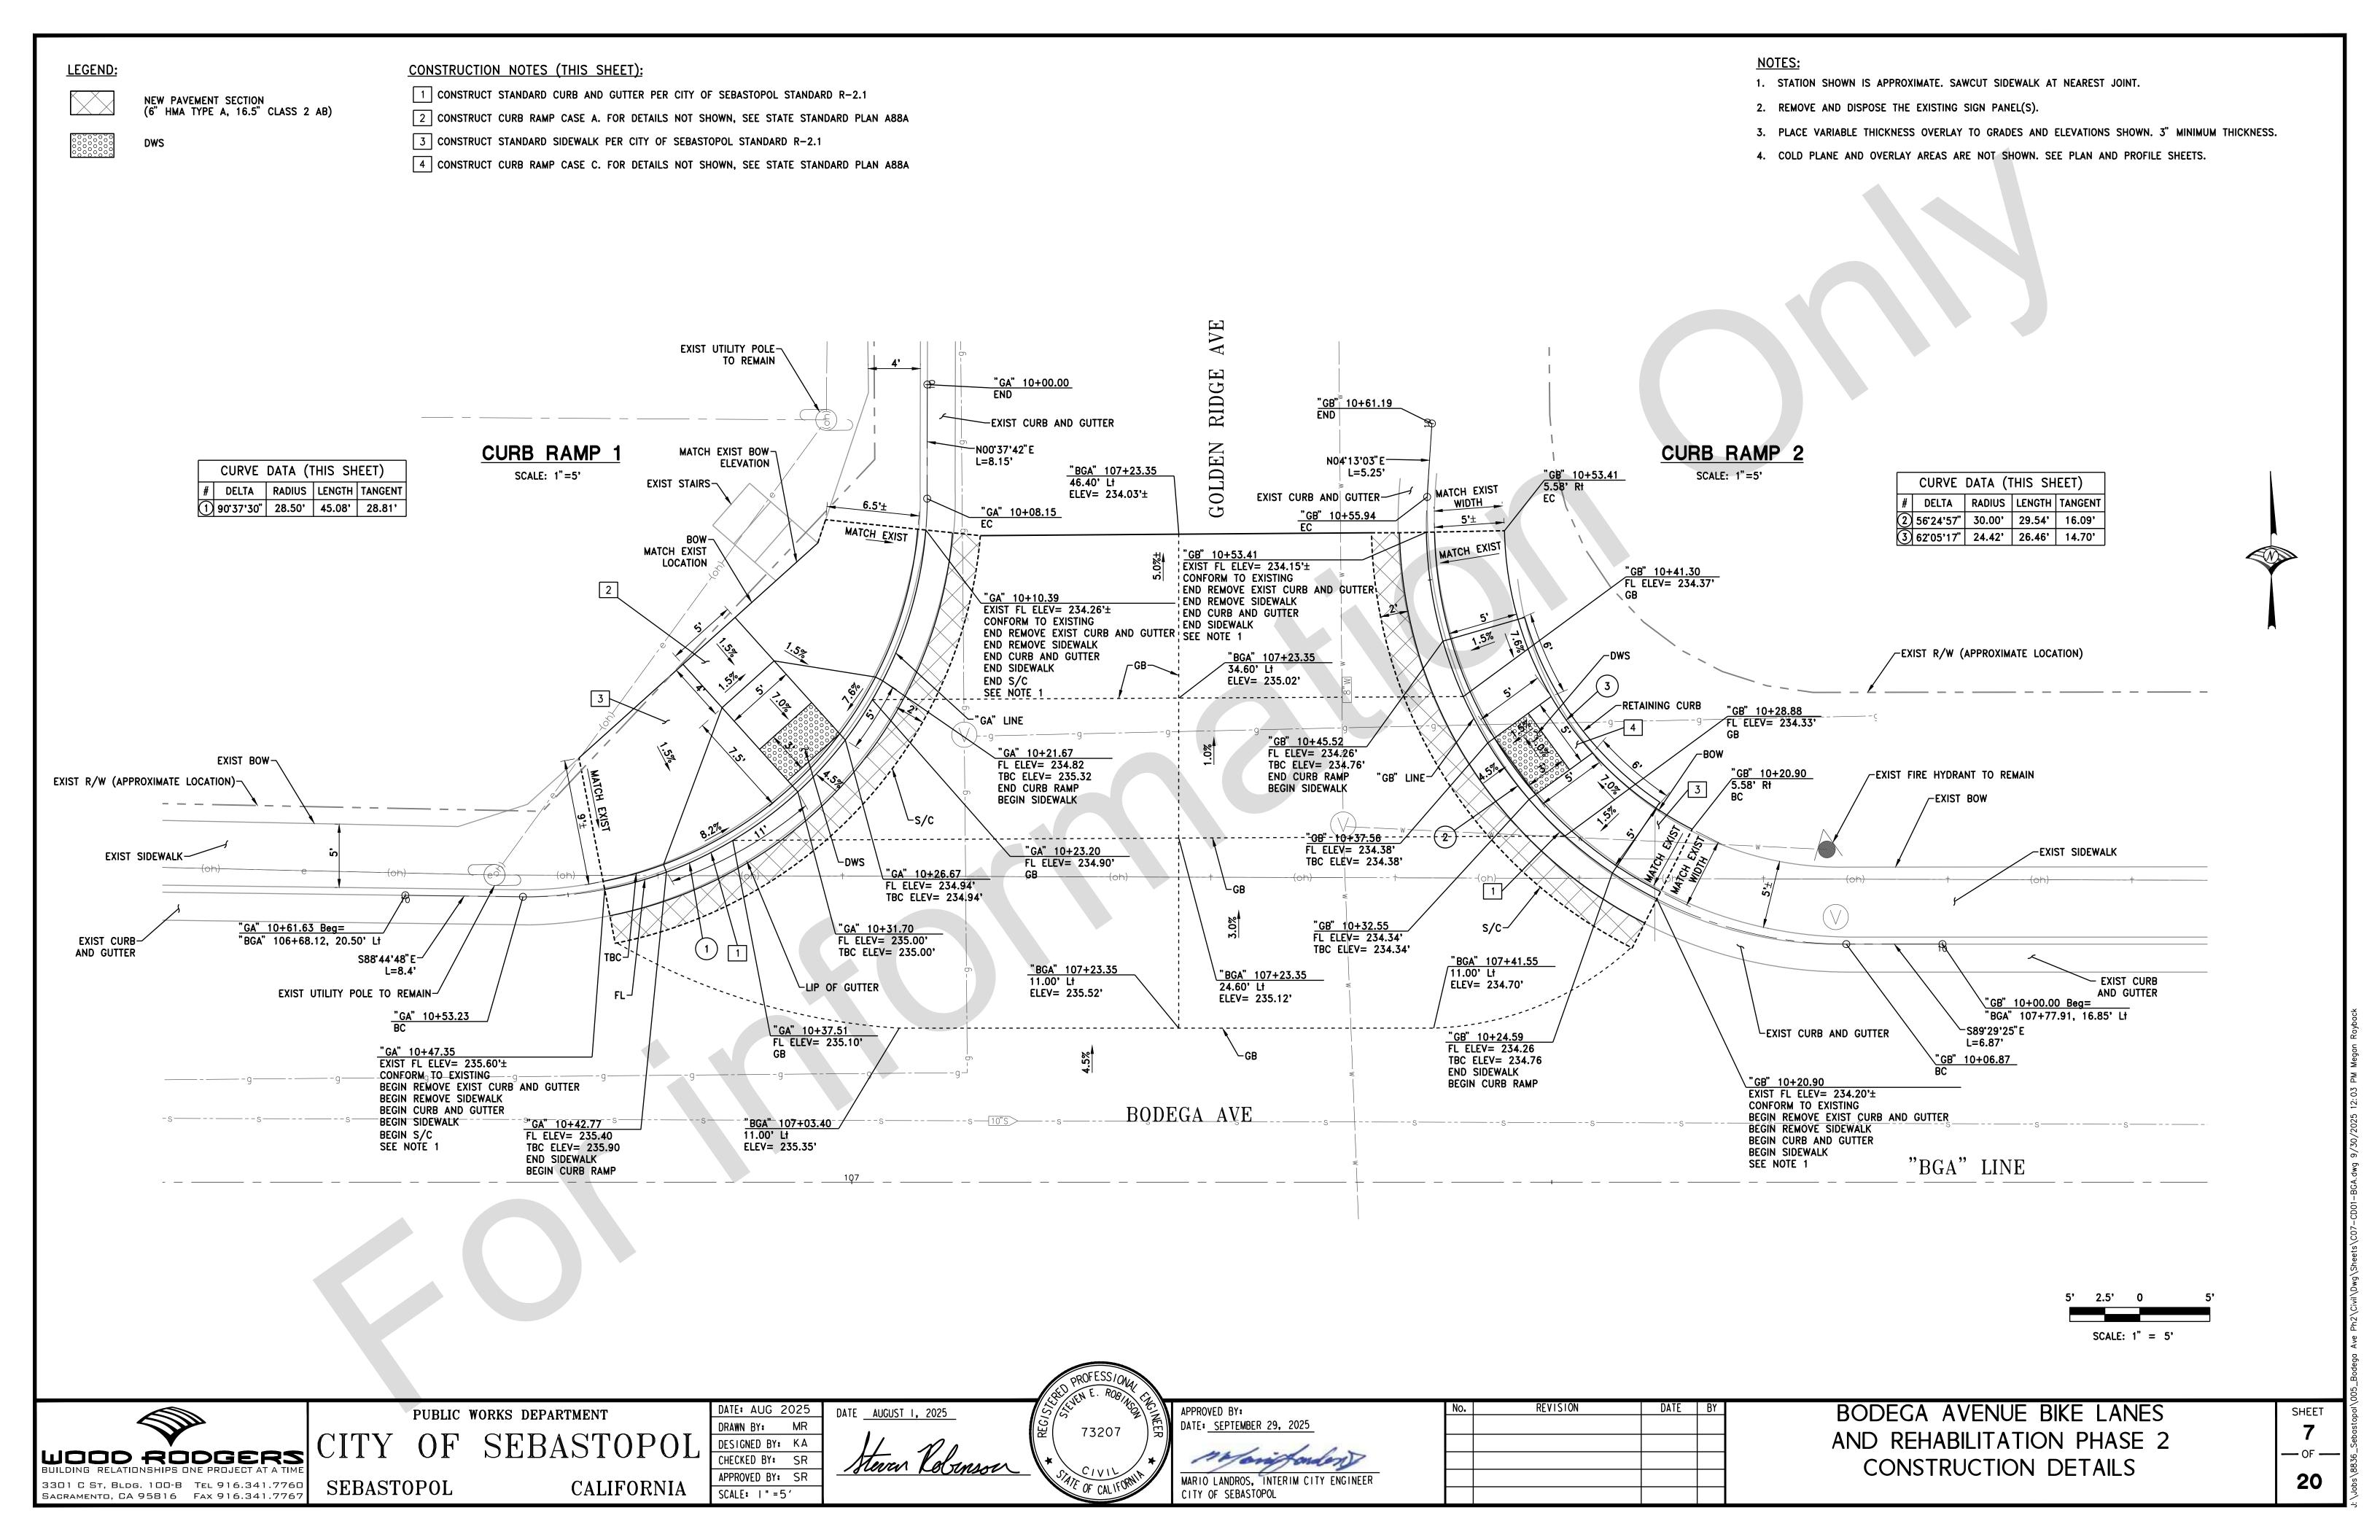

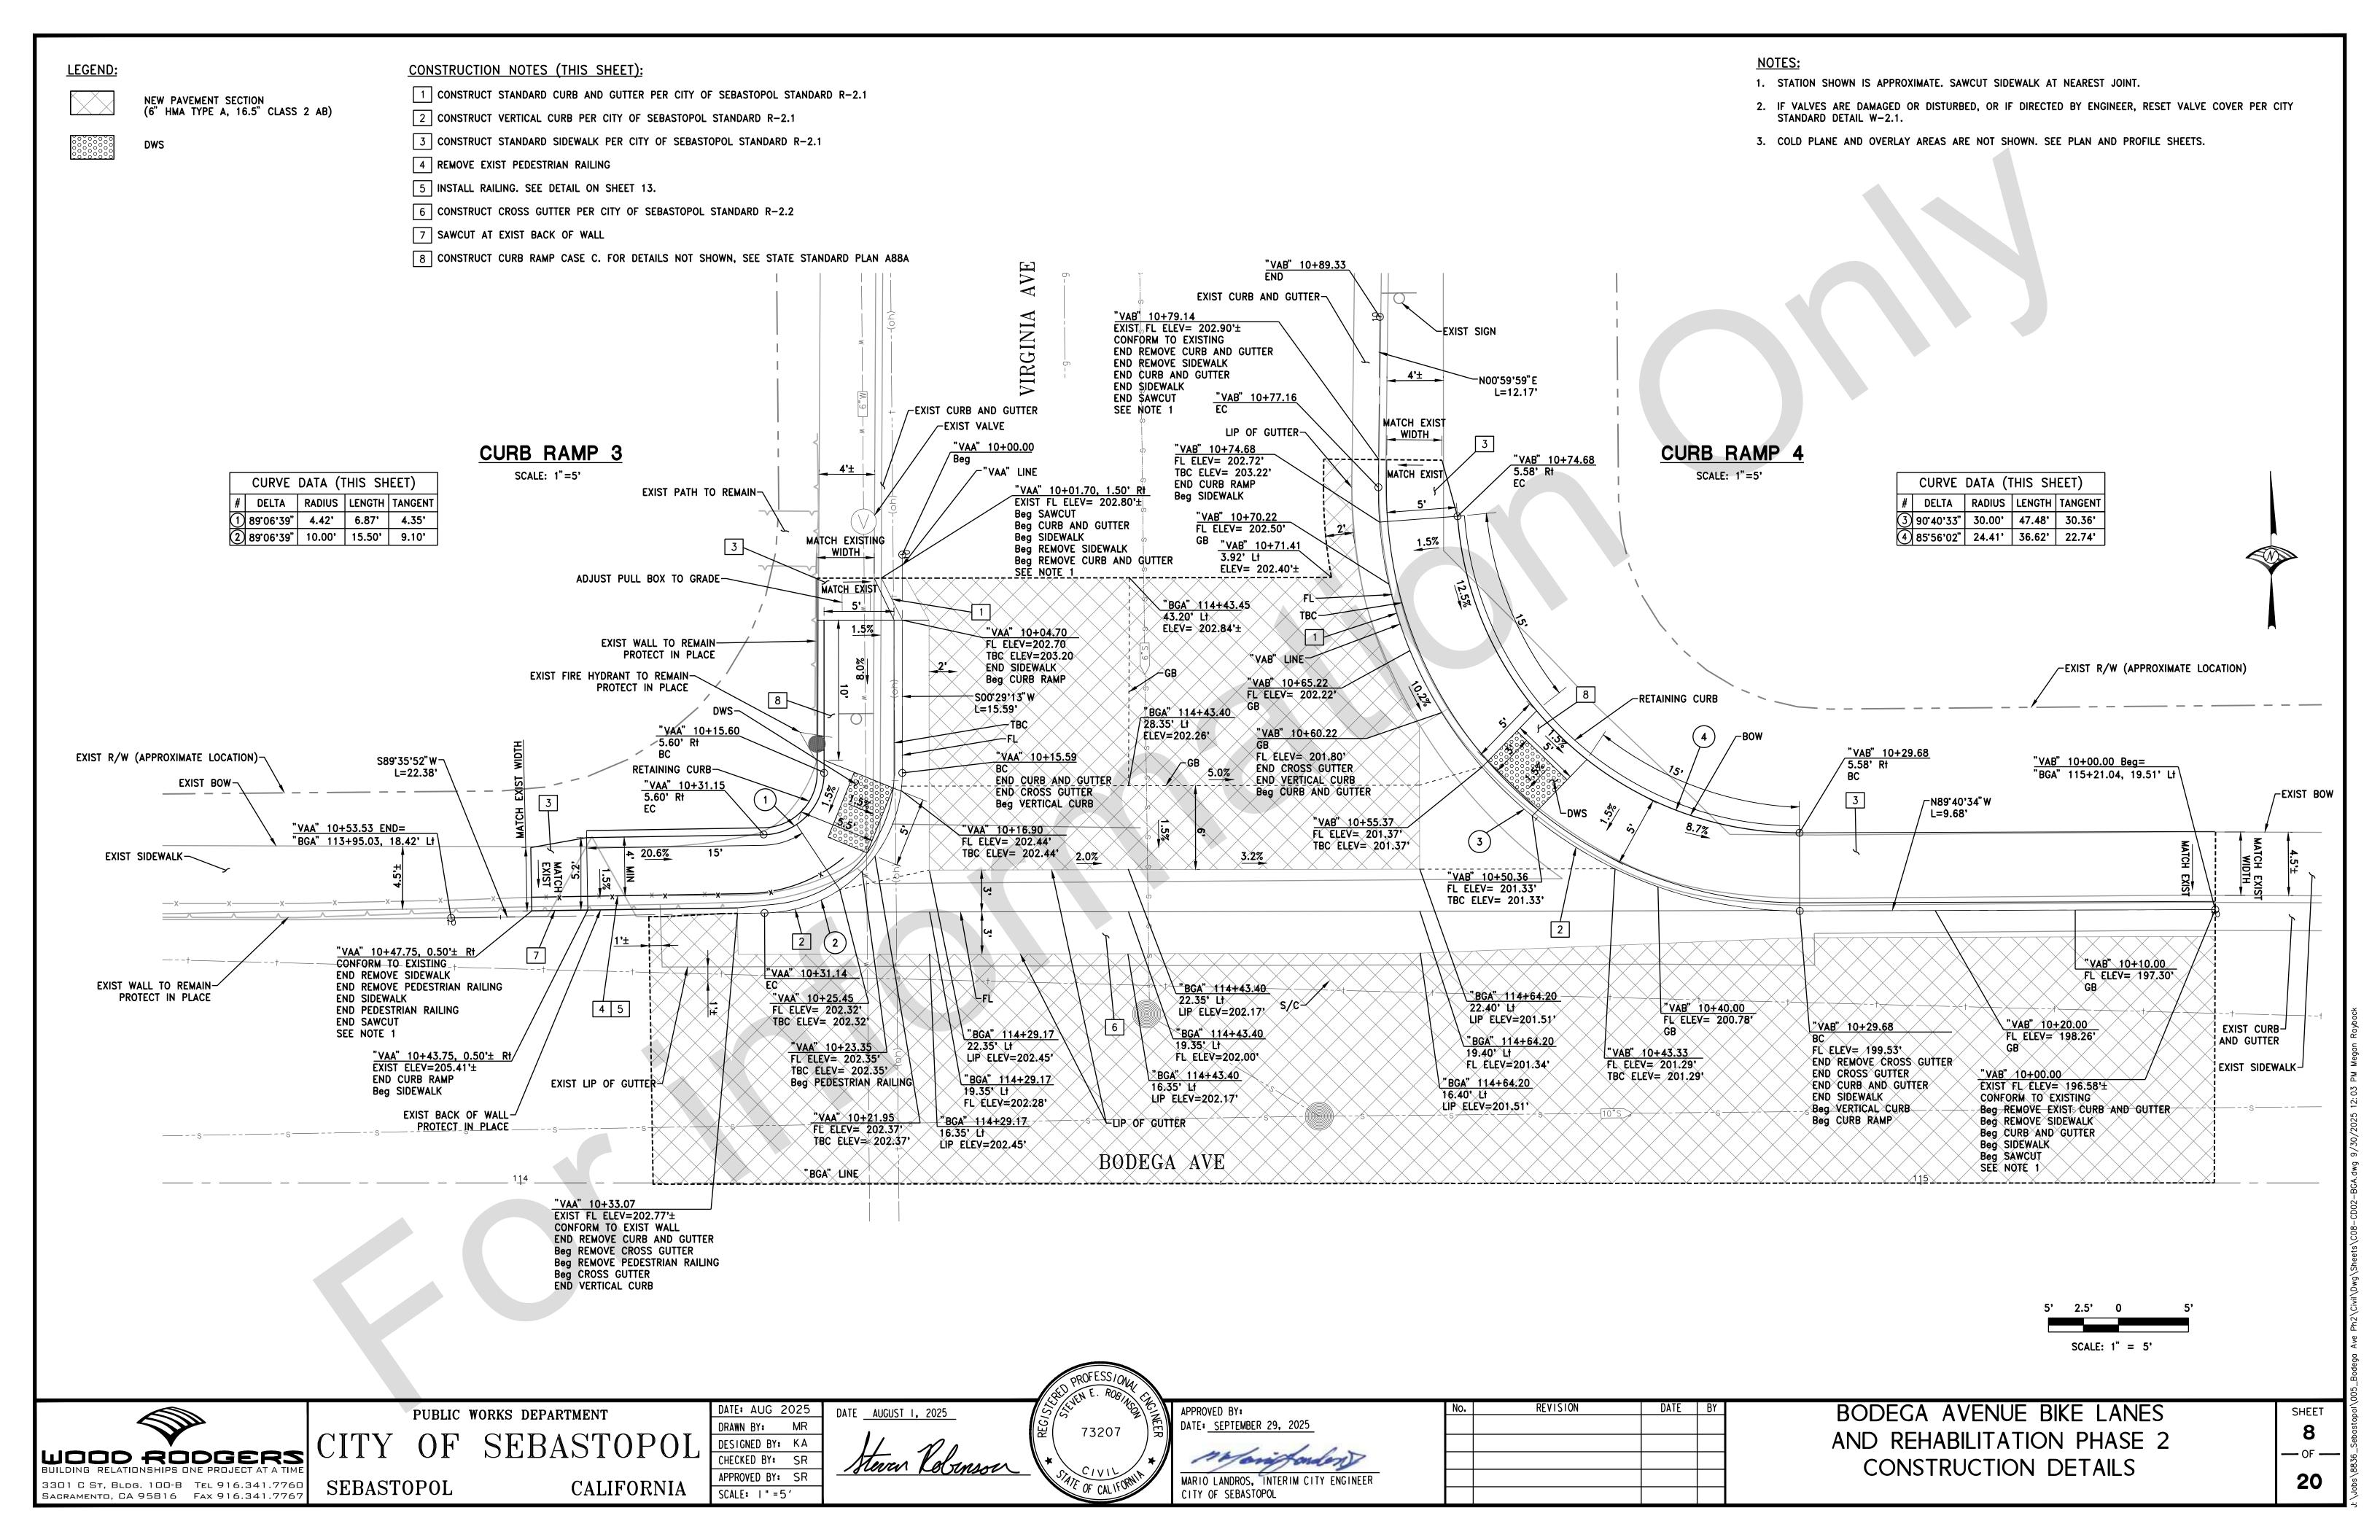

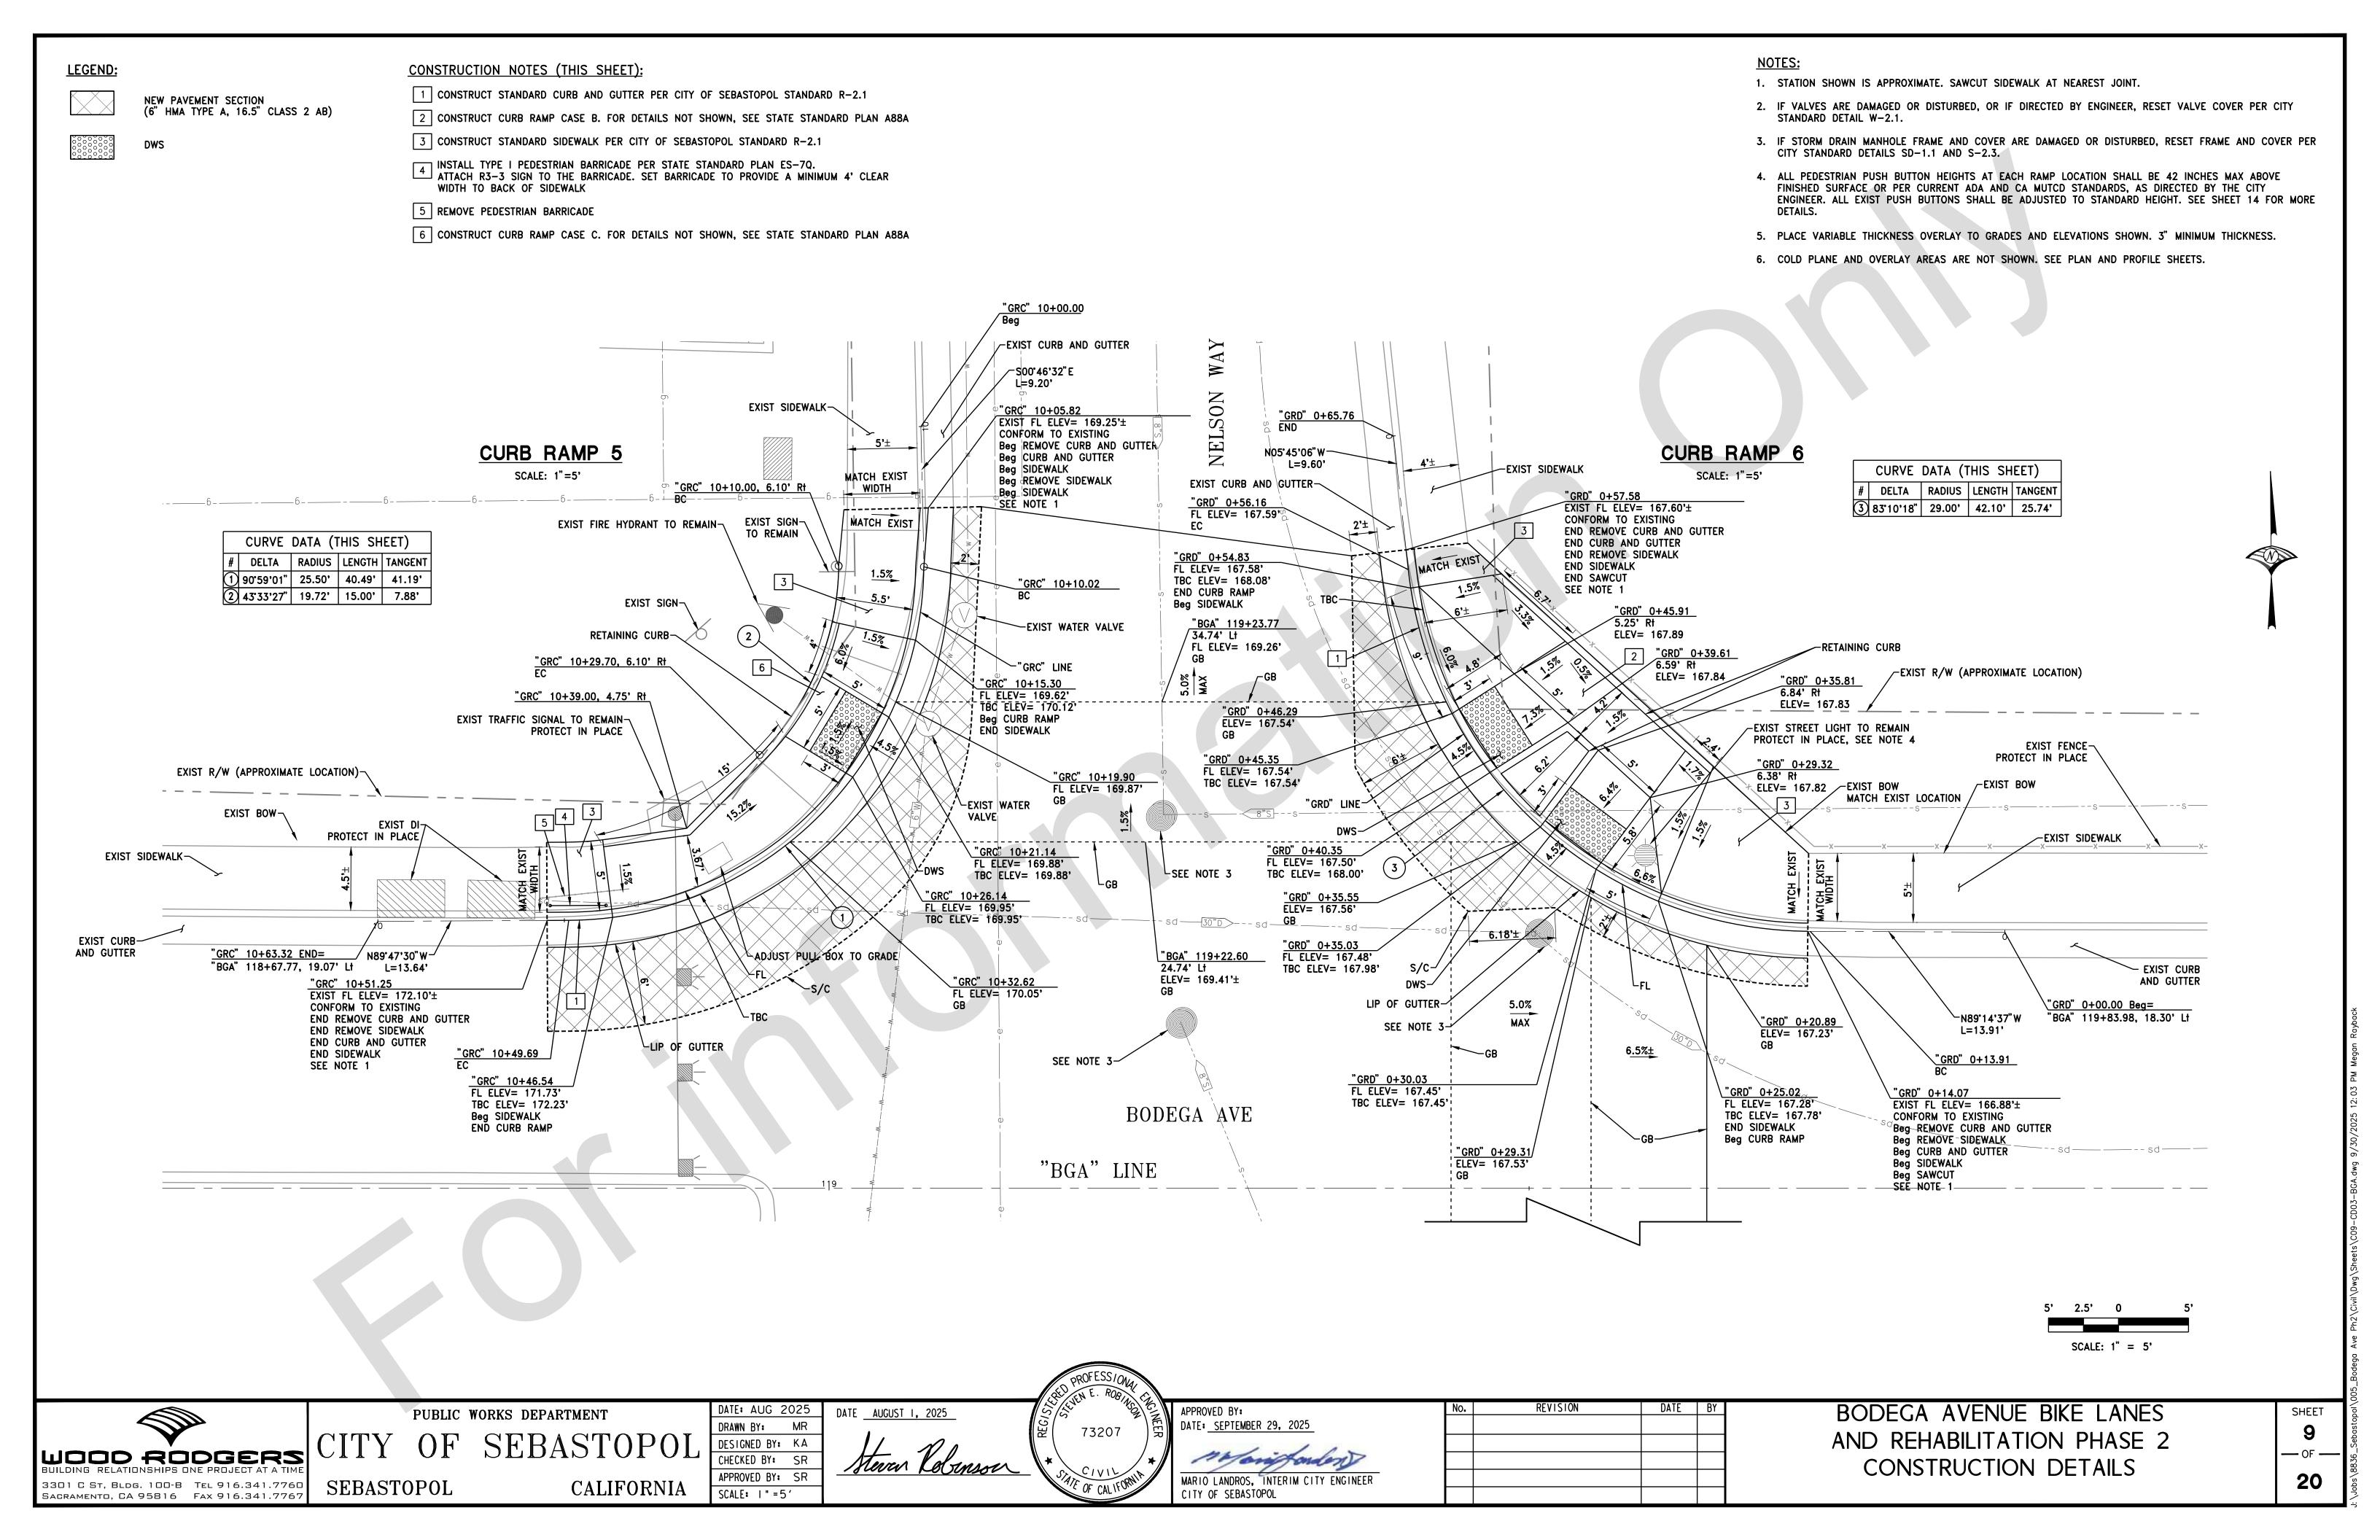

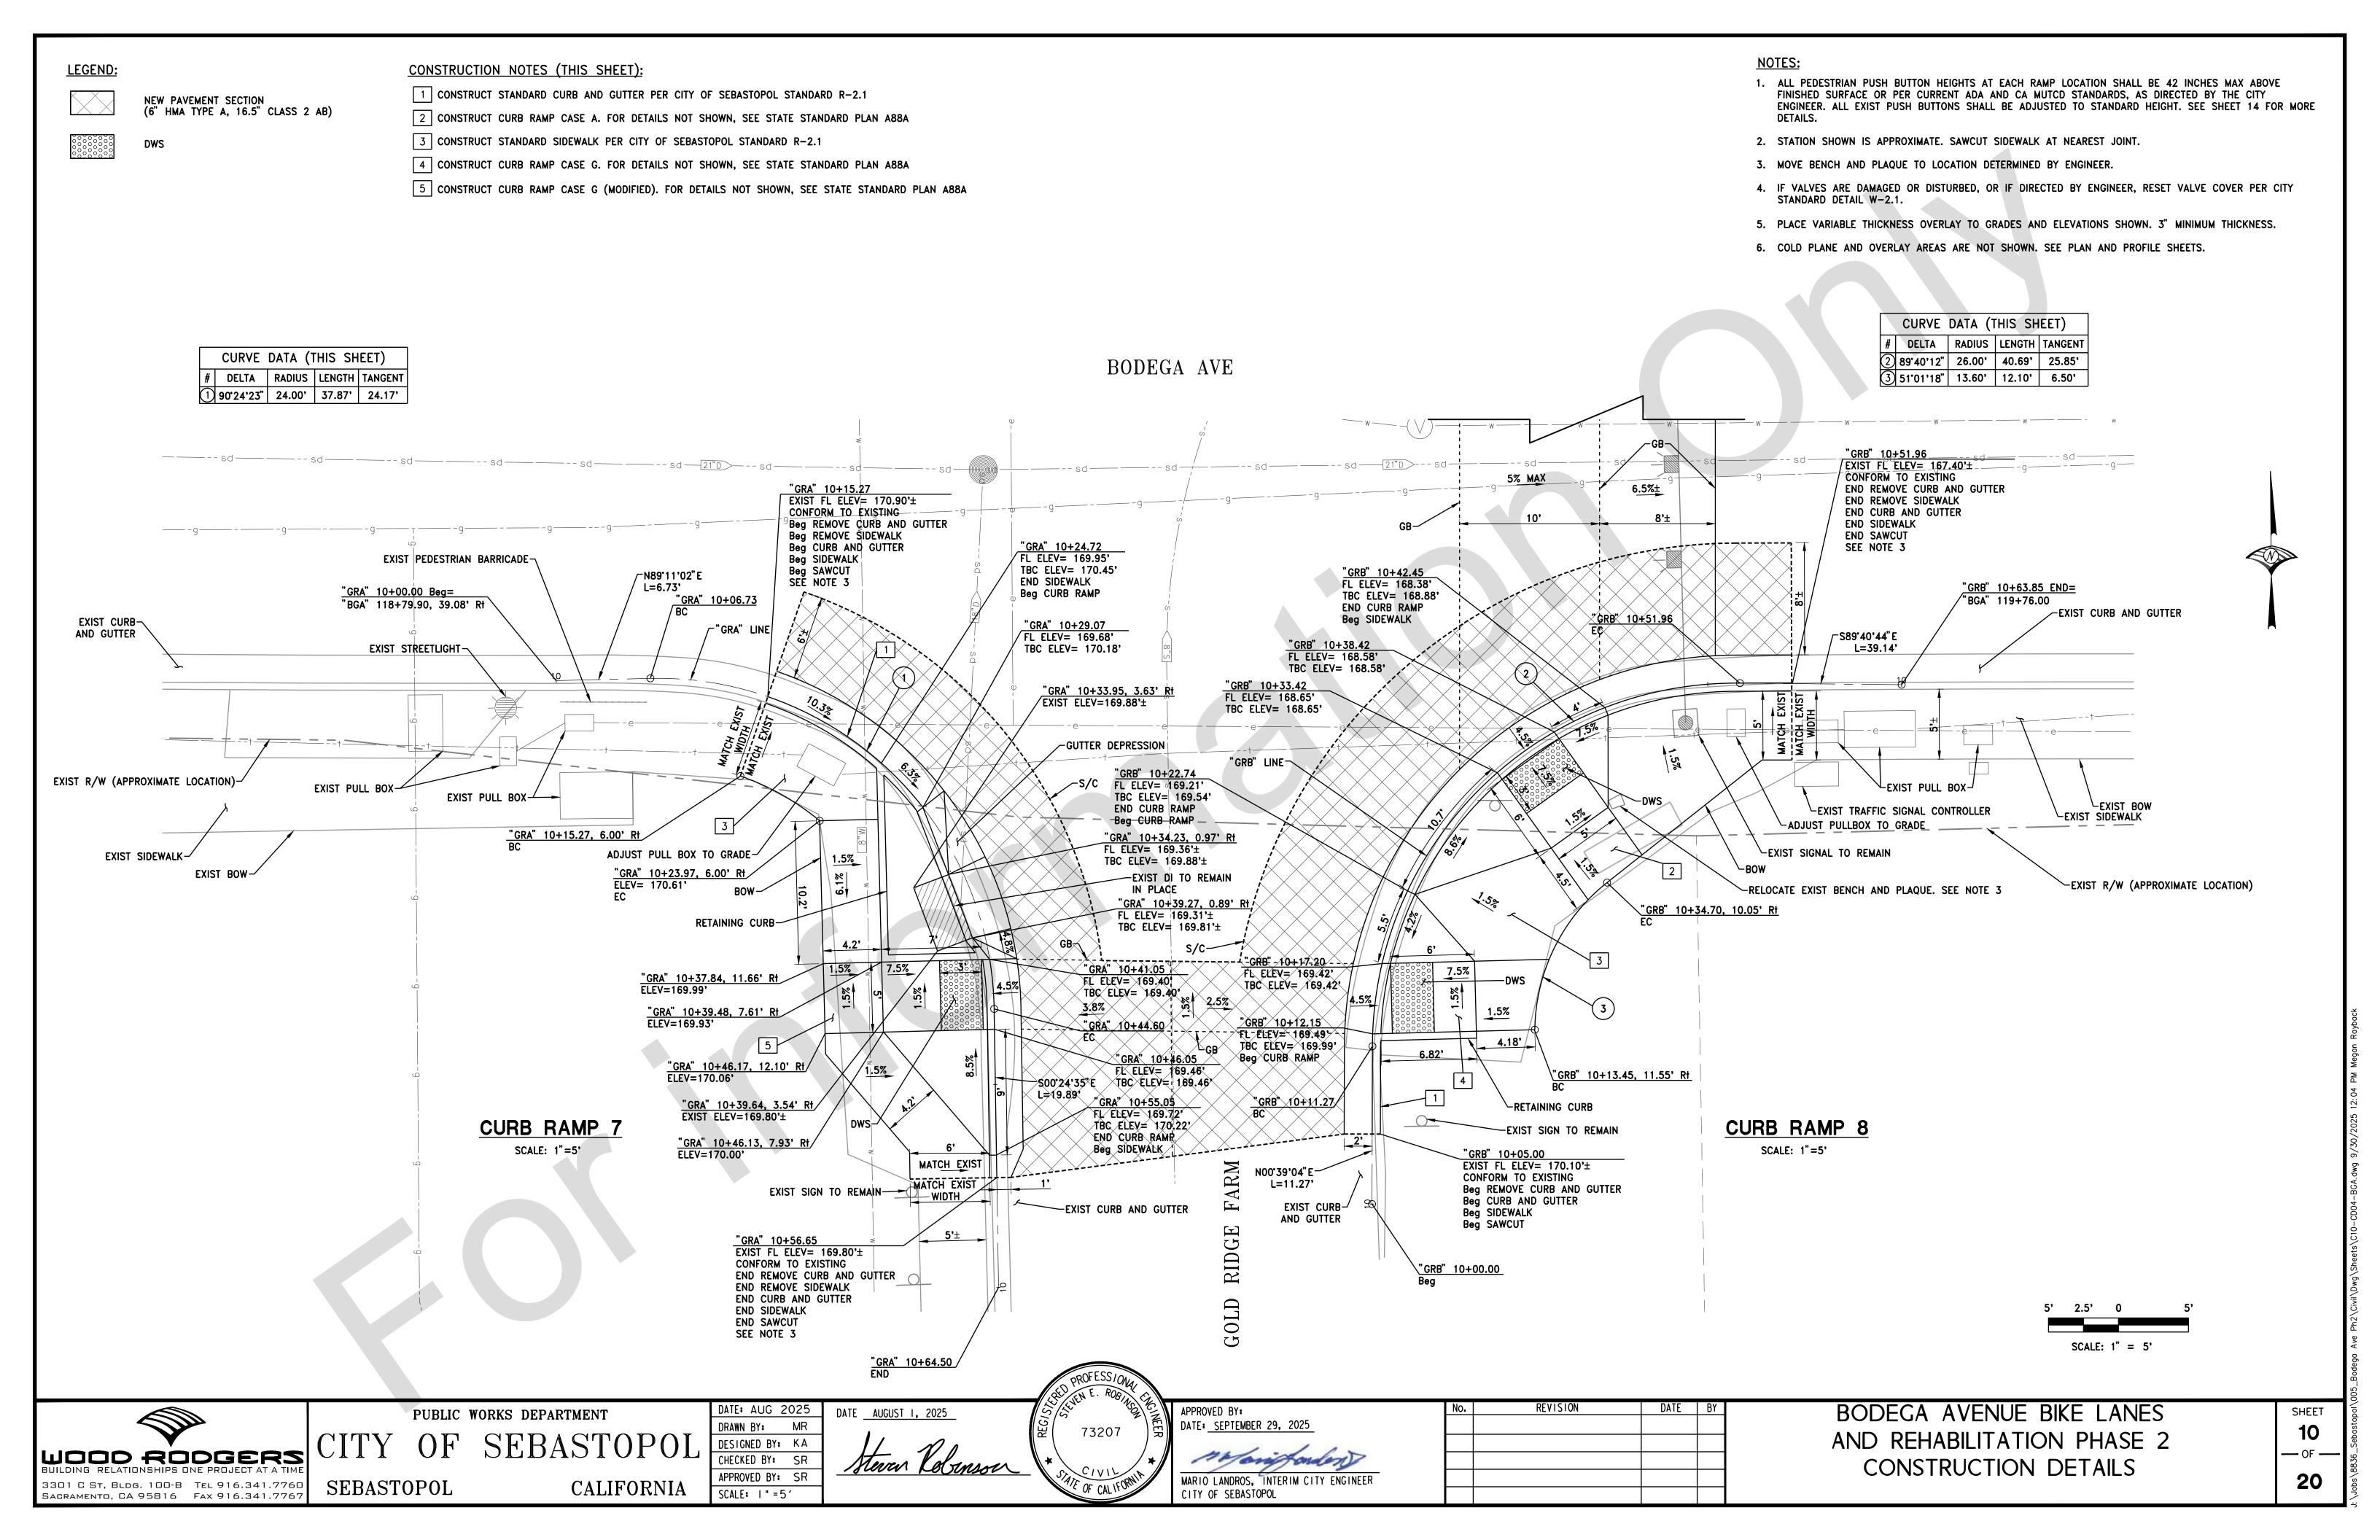

NOTES: **LEGEND: CONSTRUCTION NOTES(THIS SHEET):** 1 CONSTRUCT STANDARD CURB AND GUTTER PER CITY OF SEBASTOPOL STANDARD R-2.1 1. STATION SHOWN IS APPROXIMATE. SAWCUT SIDEWALK AT NEAREST JOINT. NEW PAVEMENT SECTION (6" HMA TYPE A, 16.5" CLASS 2 AB) 2. IF VALVES ARE DAMAGED OR DISTURBED, OR IF DIRECTED BY ENGINEER, RESET VALVE COVER PER CITY STANDARD DETAIL W-2.1. 2 CONSTRUCT CROSS GUTTER PER CITY STANDARD R-2.1 3 CONSTRUCT STANDARD VERTICAL CURB PER CITY OF SEBASTOPOL STANDARD R-2.1 3. COLD PLANE AND OVERLAY AREAS ARE NOT SHOWN. SEE PLAN AND PROFILE SHEETS. "BGA" LINE BODEGA AVE "BGA" 106+73.35, 11.00' Rt ELEV= 236.48' LIP OF GUTTER-"BGA" 106+73.35, 15.00' Rt LIP ELEV= 236.28' "BGA" 106+69.35 15.00' Rt -LIP OF GUTTER "BGA" 106+89.35 16.00' Rt "BGA" 106+57.35 16.00' Rt "BGA" 106+62.36, 18.00' FL ELEV= 236.24'
END CURB AND GUTTER
Beg CROSS GUTTER
Beg VERTICAL CURB "BGA" 106+66.94, 21.00' Rt FL ELEV= 236.38' "BGA" 106+73.35, 18.00' Rt FL ELEV= 236.11' TOP OF SLOPE-LEXIST UTILITY POLE "BGA" 106+67.36, 23.00' Rt FL ELEV= 236.38' "BGA" 106+73.35, 21.00' Rt LIP ELEV= 236.28' "BGA" 106+89.35, 18.00' Rt LIP OF GUTTER EXIST R/W (APPROXIMATE LOCATION)-"BGA" 106+67.35, 28.00' Rt
EXIST FL ELEV= 236.30'±
CONFORM TO EXISTING
END VERTICAL CURB FL ELEV= 235.88'
END CROSS GUTTER
Beg CURB AND GUTTER
END VERTICAL CURB EXIST EP-"BGA" 106+73.35, 28.00' Rt / EXIST ELEV= 236.35'± "BGA" 106+79.95, 28.00' Rt EXIST FL ELEV= 236.06'±
CONFORM TO EXISTING
Beg VERTICAL CURB CURVE DATA (THIS SHEET) **DRIVEWAY 1** # DELTA RADIUS LENGTH TANGENT SCALE: 1"=5' 1 89.59.09, 5.00, 7.82, 5.00, ② 89·59·09" 10.00' 15.71' 10.00' 5' 2.5' 0 SCALE: 1" = 5' BODEGA AVENUE BIKE LANES REVISION PUBLIC WORKS DEPARTMENT DATE AUGUST 1, 2025 DRAWN BY: MR DATE: SEPTEMBER 29, 2025 SEBASTOPOL AND REHABILITATION PHASE 2 DESIGNED BY: KA WOOD RODGERS CHECKED BY: SR CONSTRUCTION DETAILS

3301 C ST, BLDG. 100-B TEL 916.341.7760 SACRAMENTO, CA 95816 FAX 916.341.7767


SEBASTOPOL


CALIFORNIA

APPROVED BY: SR SCALE: | " = 5 '


Steven Kolenson


MARIO LANDROS, INTERIM CITY ENGINEER CITY OF SEBASTOPOL

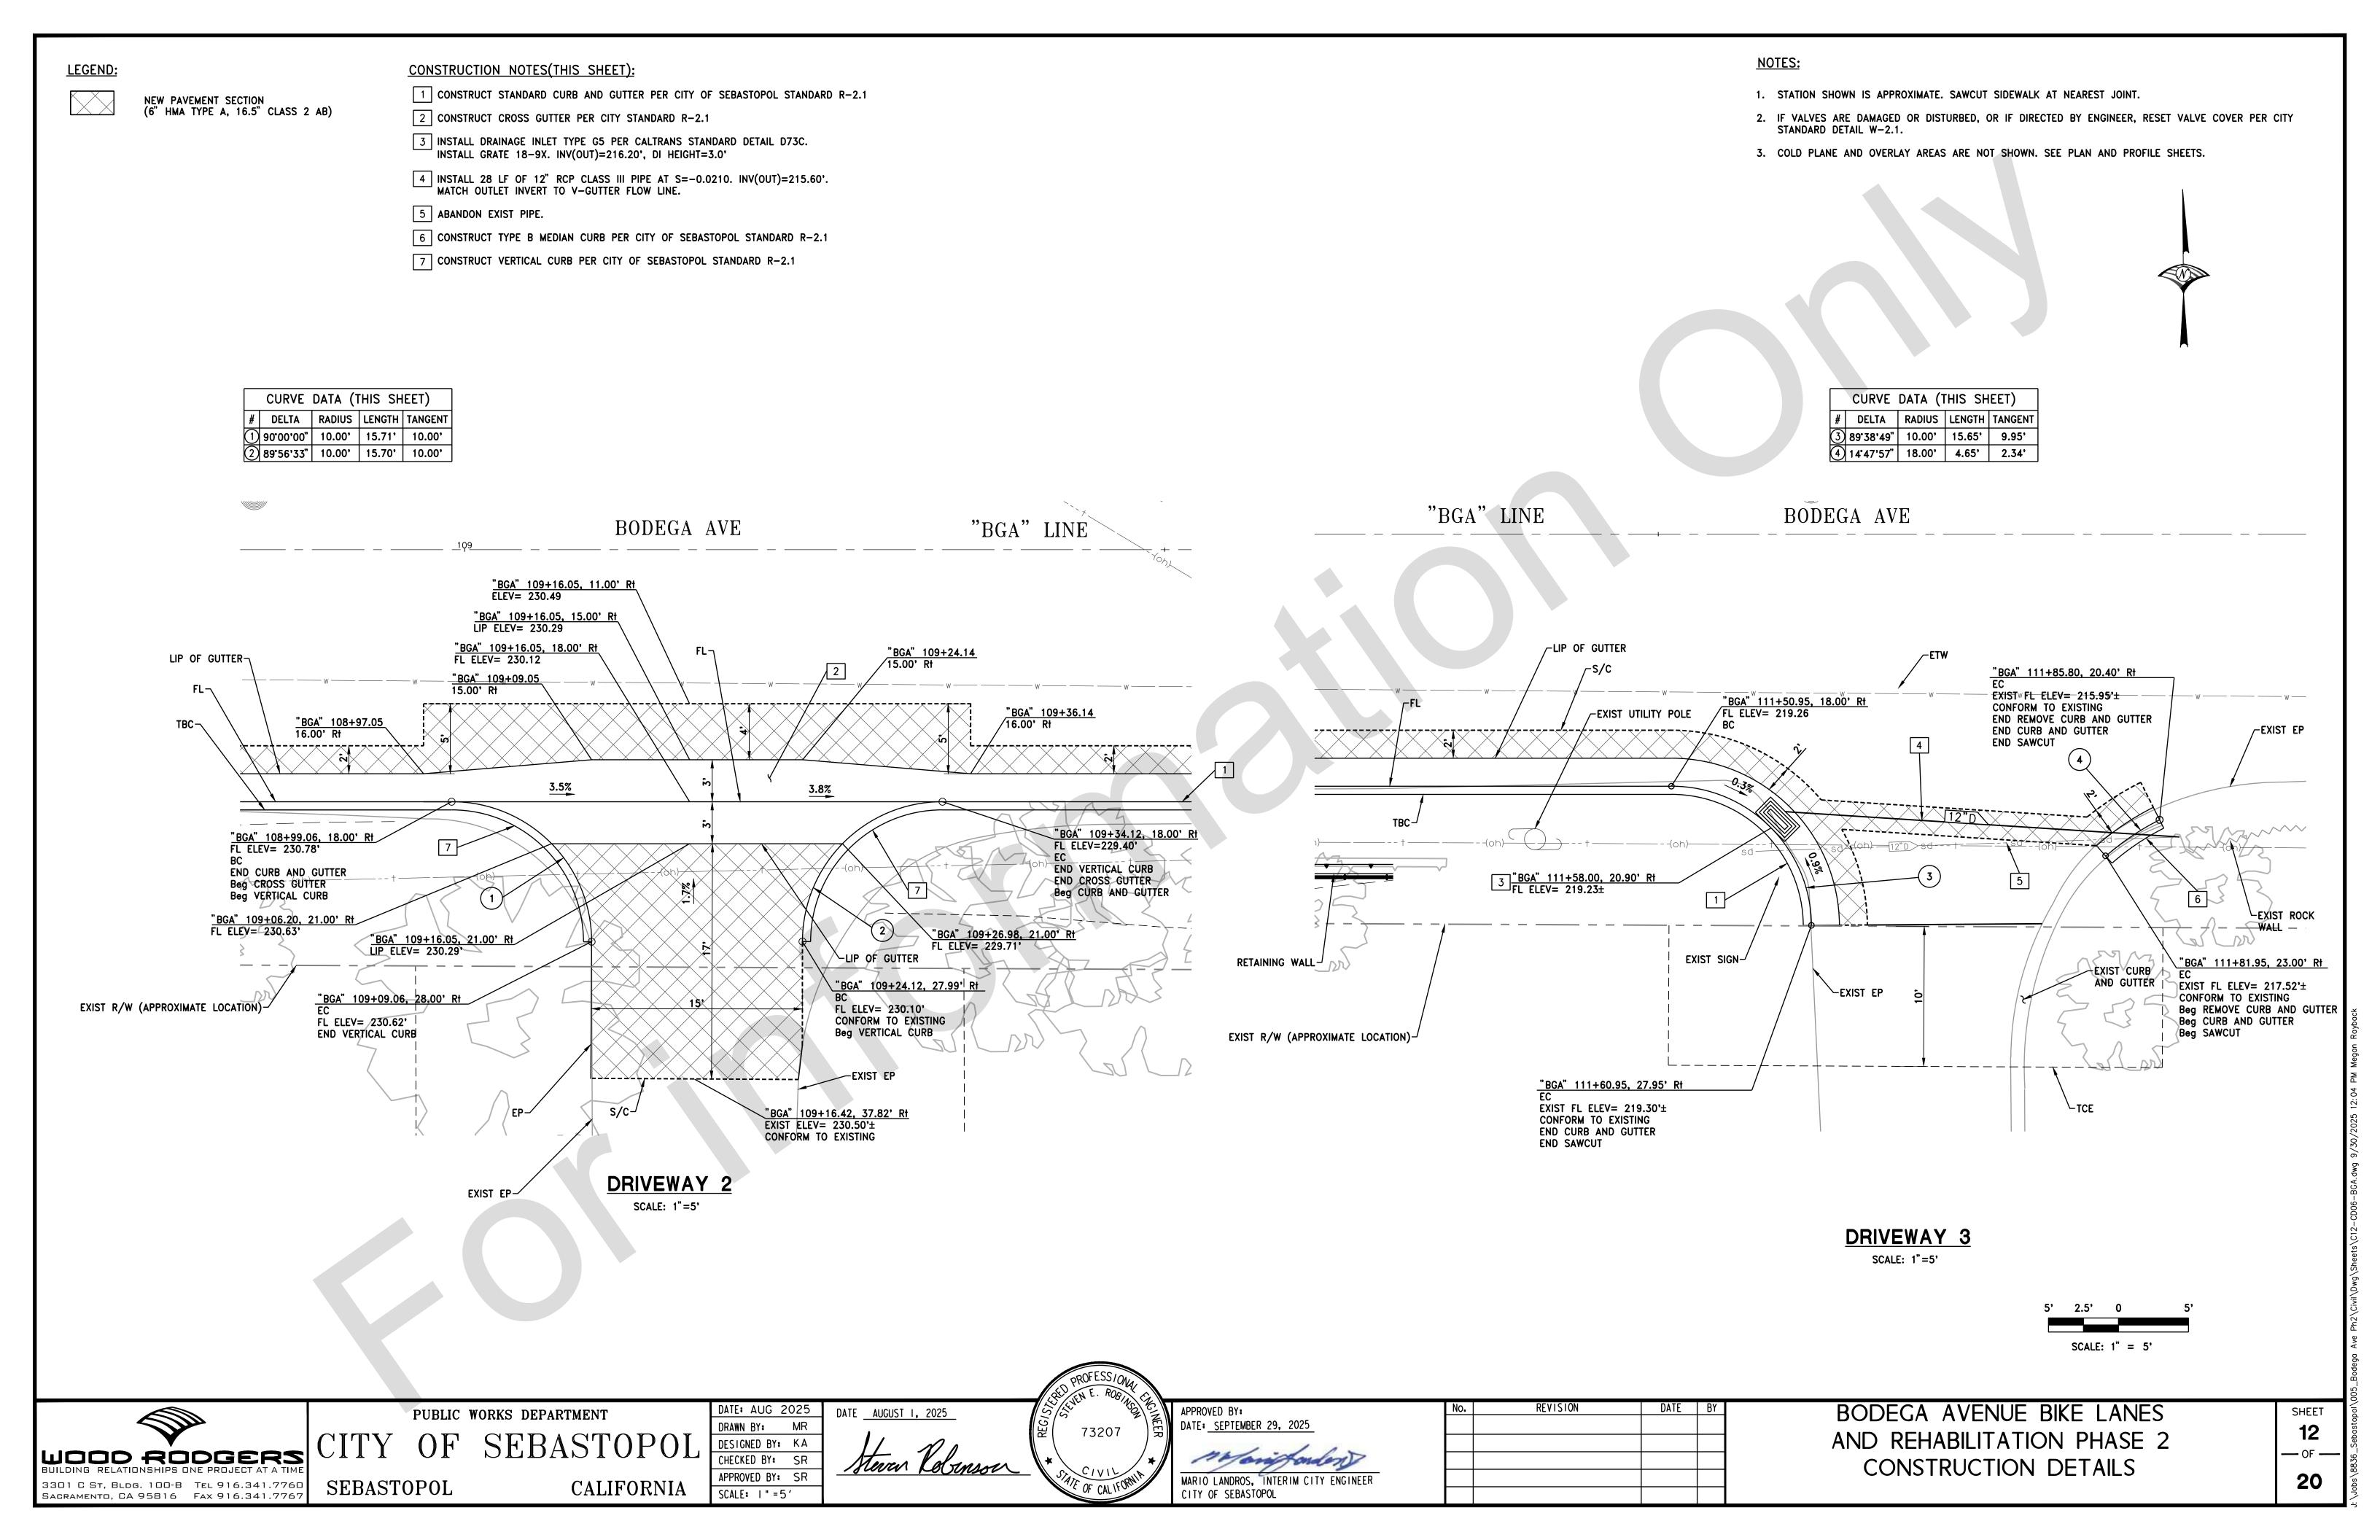

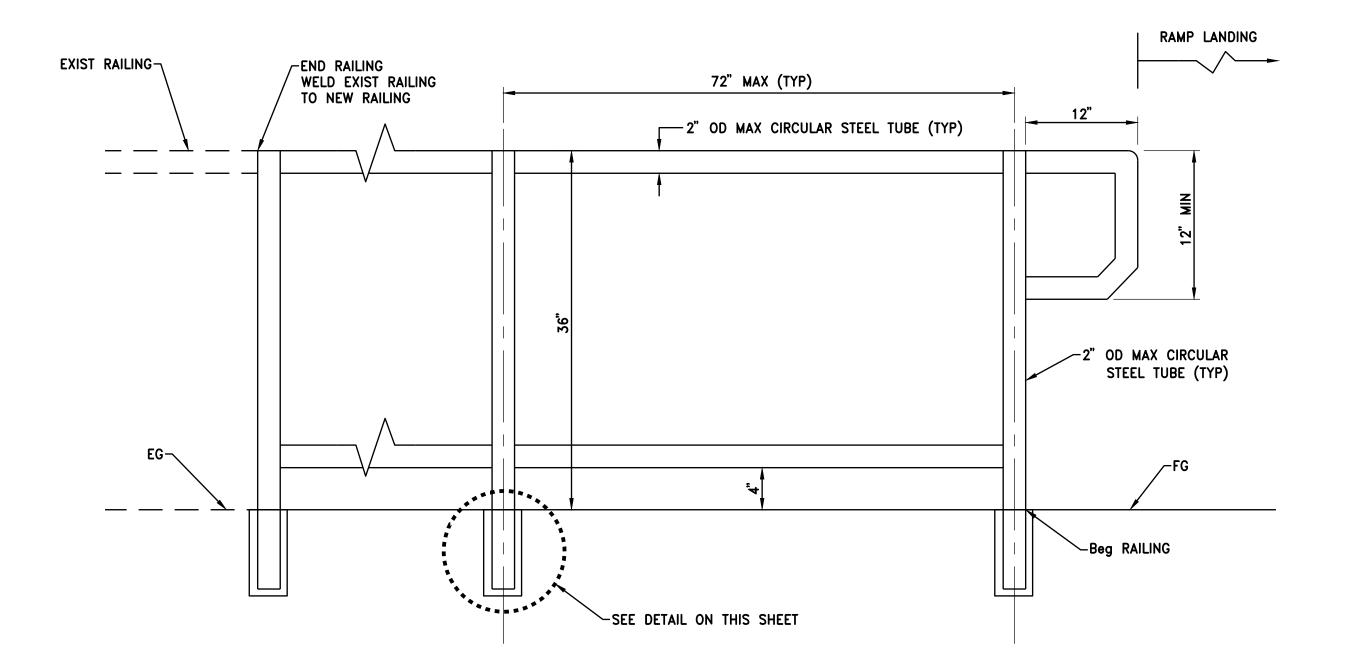

**ELEVATION** 

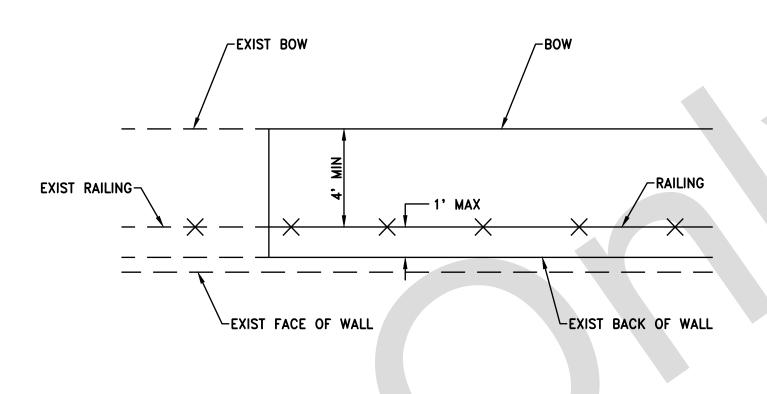

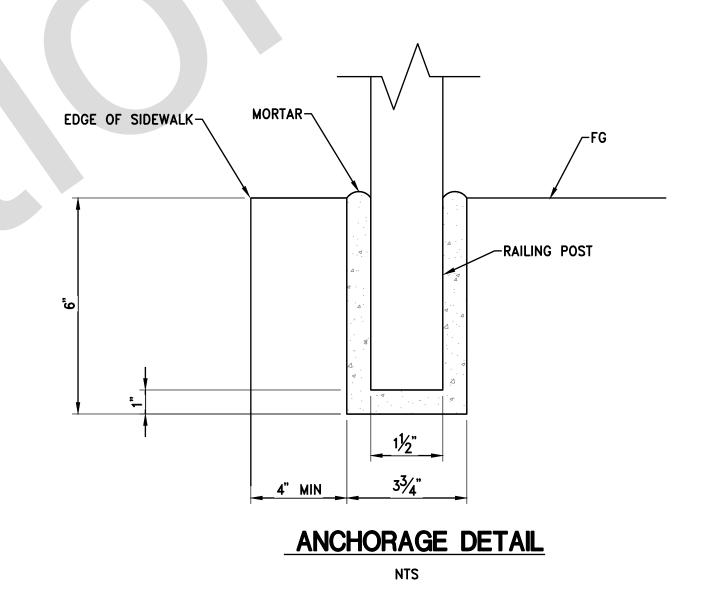

### PEDESTRIAN RAILING DETAIL



PUBLIC WORKS DEPARTMENT CITY OF SEBASTOPOL SEBASTOPOL CALIFORNIA

DATE: AUG 2025
DRAWN BY: MR DESIGNED BY: KA
CHECKED BY: SR
APPROVED BY: SR

APPROVED BY:
DATE: <u>SEPTEMBER 29, 2025</u> MARIO LANDROS, INTERIM CITY ENGINEER CITY OF SEBASTOPOL

BODEGA AVENUE BIKE LANES AND REHABILITATION PHASE 2 CONSTRUCTION DETAILS

#### NOTES (CONCRETE COLLAR):

- 1. PIPE EXTENSION SHALL BE POSITIONED TO PROVIDE FOR A SMOOTH TRANSITION AT THE PIPE FLOWLINE.
- 2. INTERIOR FORM SHALL BE PLACED TO PREVENT CONCRETE INTRUSION INTO PIPE INTERIOR.
- 3. REINFORCEMENT SHALL BE PLACED 1.5" CLEAR FROM OUTSIDE DIAMETER OF PIPE.
- 4. COLLAR TO BE USED FOR JOINING NEW PIPE TO EXISTING PIPE AND PIPES OF DIFFERENT SIZES AS SHOWN ON THE PLANS.

#### CONCRETE COLLAR DETAIL

#### PIPE TRADE SIZE 1/2" (IN) OR LESS FOR UNC OR UNF THREADS: FOR NATIONAL PIPE THREADS - APPLY SILICONE CAULK TO THREADS OF SS BOLT WITH SHANK. - TIGHTEN SS BOLT UNTIL SHANK IS TIGHT AGAINST STANDARD.

- CUT OFF SS BOLT EVEN WITH STANDARD.

APPLY TWO COATS PAINT SHALL BE DRY BEFORE APPLYING SECOND COAT.

- FILE SS BOLT TO MATCH CONTOUR OF STANDARD.

- TREAT SS BOLT AND SURROUNDING POLE WITH GALVANIZING REPAIR PAINT

REPAIR PROCEDURE - BOLT HOLE SIZE 1/2" (IN) DIAMETER OR LESS ~

- APPLY SILICONE CAULK TO THREADS OF HOT-DIPPED GALVANIZED HEX SOCKET PIPE PLUG.
- TIGHTEN PLUG UNTIL FLUSH WITH STANDARD.
- FILE PLUG TO MATCH CONTOUR OF STANDARD.
- FILL HEX SOCKET WITH PAINTABLE SILICONE CAULK

TREAT PLUG AND SURROUNDING POLE WITH GALVANIZING REPAIR PAINT - APPLY TWO COATS PAINT SHALL BE DRY BEFORE APPLYING SECOND COAT.


#### - SUBMITTAL PER STANDARD SPECIFICATION 6-03.3(25).

REPAIR PROCEDURE - MAXIMUM HOLE SIZE 3" (IN) DIAMETER OR LESS

- MAXIMUM HOLE SIZE 3" (IN) OR LESS IN DIAMETER.
- 1/8" (IN) STEEL PLATE TYPE ASTM A 36 ELECTRODE TYPE XX-70.
- THE PLATE SHALL BE 1/2" (IN) LARGER THAN THE DIAMETER OF THE HOLE TO BE REPAIRED (1/4" (IN) OVERLAP ALL SIDES).
- TACK WELD PLATE TO POLE.
- SHAPE PLATE TO MATCH TAPER AND CURVE OF POLE.

EXAMPLE WITH 2" (IN) DIAMETER HOLE SHOWN

- 1/8" (IN) FILLET WELD ALL AROUND.
- CHAMFER (GRIND) EDGE OF PLATE SMOOTH REMOVE ALL BURRS AND SHARP EDGES.
- TREAT PATCH PLATE AND SURROUNDING POLE WITH GALVANIZING REPAIR
  PAINT
- APPLY TWO COATS PAINT SHALL BE DRY PRIOR TO APPLYING SECOND COAT.

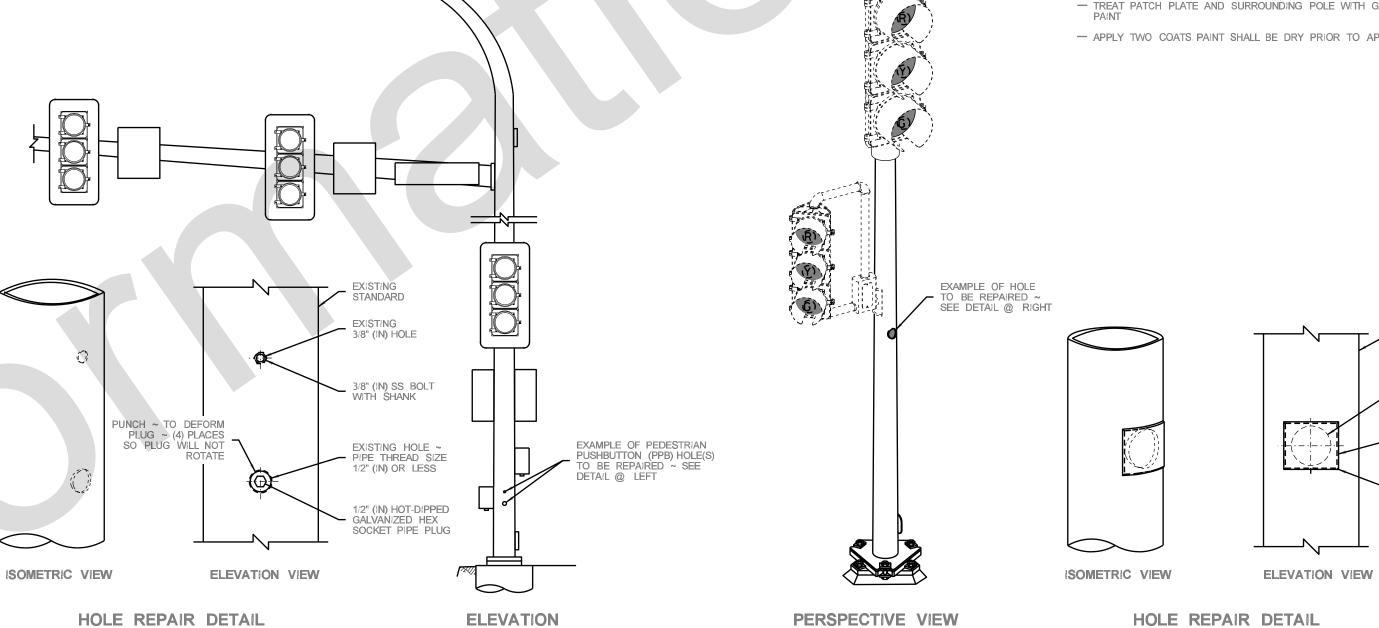

## TRAFFIC SIGNAL POLE MODIFICATION DETAIL

PERSPECTIVE VIEW

(RAMP METER SIGNAL STANDARD

WITH SLIP BASE SHOWN)




PUBLIC WORKS DEPARTMENT

SEBASTOPOL

DRAWN BY: MR SEBASTOPOL DESIGNED BY: KA CHECKED BY: APPROVED BY: SR CALIFORNIA

Steven Kolenson

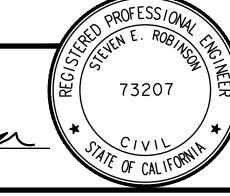

EXAMPLE OF REPAIR FROM PPB LOCATION ~

1/2" (IN) DIAMETER AND 3/8" (IN) DIAMETER HOLES SHOWN

APPROVED BY: DATE: <u>SEPTEMBER 29, 2025</u>

MARIO LANDROS, INTERIM CITY ENGINEER

CITY OF SEBASTOPOL


(TYPE III SIGNAL STANDARD SHOWN)

REVISION

BODEGA AVENUE BIKE LANES AND REHABILITATION PHASE 2 CONSTRUCTION DETAILS

EXISTING 2" (IN)
DIAMETER HOLE

1/8" (IN) x 2 1/2" (IN) x 2 1/2" (IN) STEEL PLATE

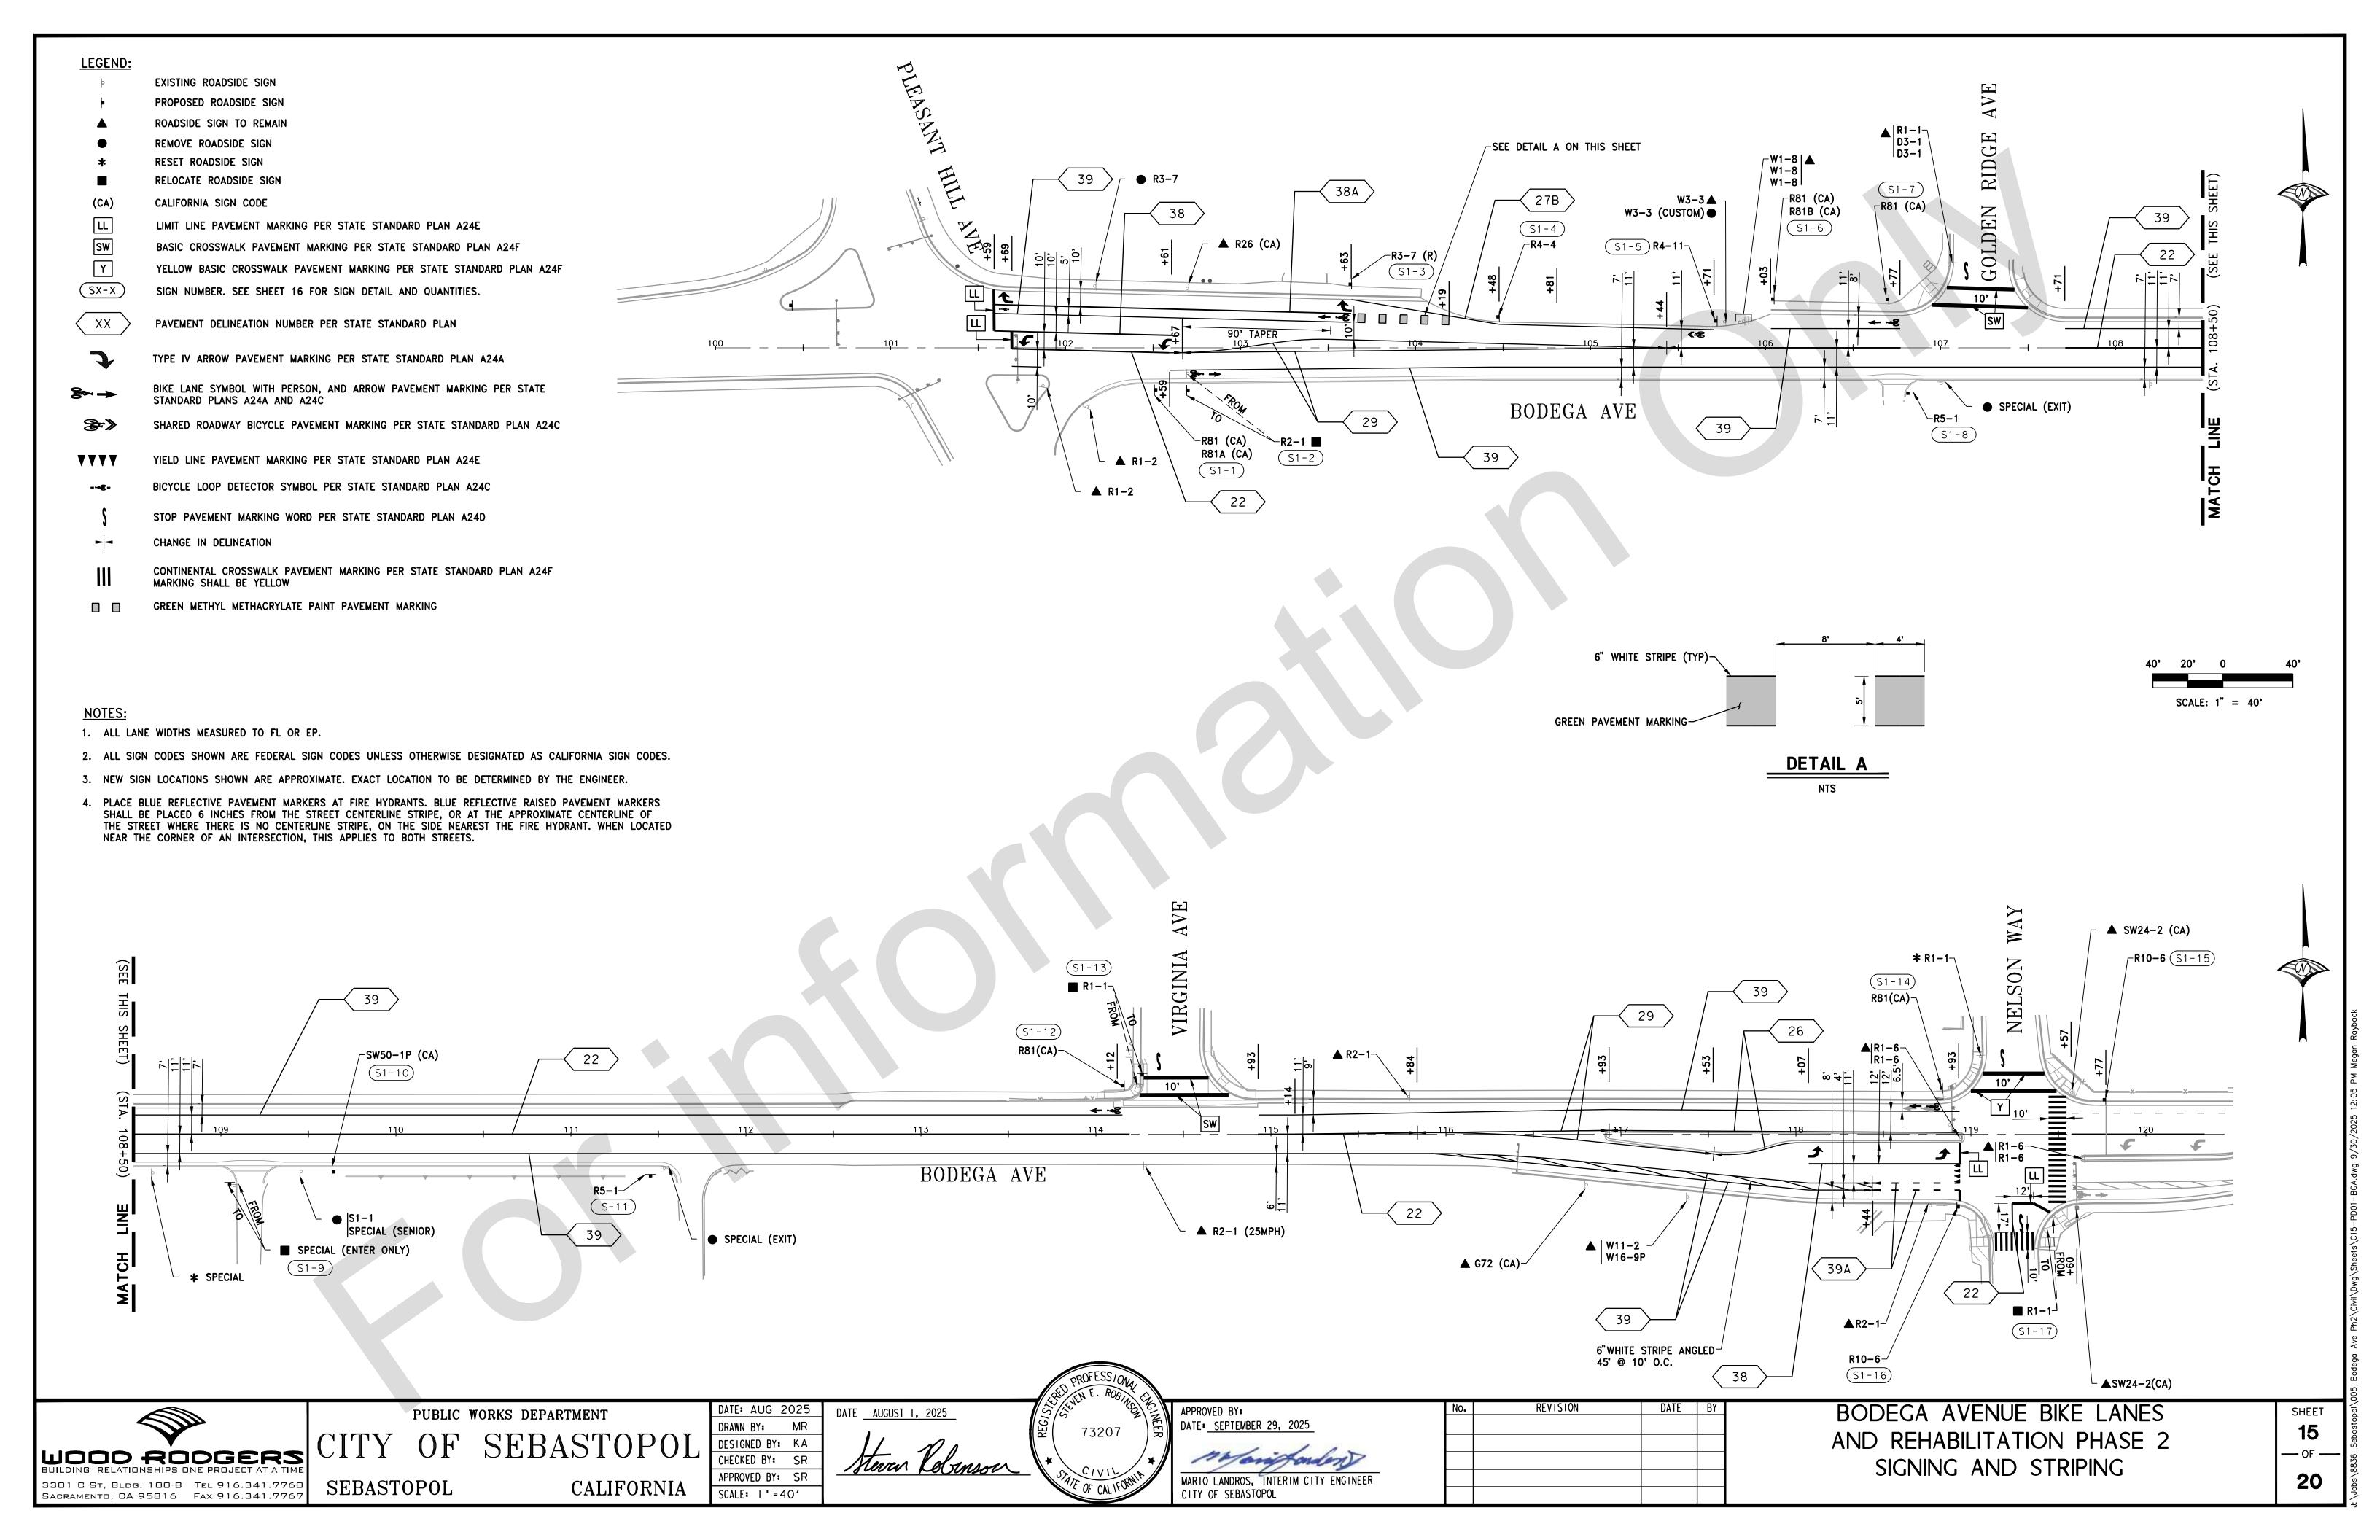

#### NOTES:

- 1. EXACT LOCATION AND POSITION OF ROADSIDE SIGNS TO BE DETERMINED BY THE ENGINEER.
- 2. POST LENGTHS GIVEN ARE APPROXIMATE.
- 3. "C" DIM = MINIMUM VERTICAL CLEARANCE BETWEEN FINISHED GRADE AND BOTTOM OF SIGN PANEL.
- 4. ALL SIGN DESIGNATIONS SHOWN ARE FEDERAL UNLESS OTHERWISE INDICATED AS A CALIFORNIA (CA) SIGN DESIGNATION.
- 5. EXISTING SIGN PANEL TO BE MOUNTED ON NEW SIGN POST.
- 6. ALL SIGN POST SHALL CONFORM TO CITY STANDARD R-5.2.

#### **ROADSIDE SIGN QUANTITIES**

					an Qoaniiii			
SHEET NUMBER	SIGN NUMBER SHT-No.	SIGN DESIGNATION	SIGN PANEL SIZE	" DIM IN FEET	POST SIZE AND LENGTH  METAL POST	INSTALL ROADSIDE SIGN ONE POST	RELOCATE ROADSIDE SIGN ONE POST	REMARKS
			INCHES	<u>ن</u>	2" PIPE	EACH	EACH	
	S1-1	R81 (CA)	12 x 8	7	10'	1		_
		R81A (CA)	12 x 5			·		
	S1-2	R2-1		7	12'		1	SEE NOTE 5
	S1-3	R3-7 (R)	30 x 30	7	12'	1		_
	S1-4	R4-4	36 x 30	7	12'	1		-
	S1-5	R4-11	30 x 30	7	12'	1		-
	S1-6	R81 (CA)	12 x 8	7	10'	1		-
4 =	04.7	R81B (CA)	8 x 5			4		_
15	S1-7	R81 (CA)	12 x 8	7	10'	1		_
	S1-8	R5-1	30 x 30	7	12'	1		_
	S1-9	SPECIAL (ENTER ONLY)		7	12'		1	SEE NOTE 5
	S1-10	SW50-1P (CA)	24 x 18	7	11'	1		_
	S1-11	R5-1	30 x 30	7	12'	1		_
	S1-12	R81 (CA)	12 x 8	7	10'	1		_
	S1-13	R1-1		7	12'		1	SEE NOTE 5
	S1-14	R81 (CA)	12 x 8	7	10'	1		_
	S1-15	R10-6	24 x 36	7	12'	1		_
	S1-16	R10-6	24 x 36	7	12'	1		_
	S1-17	R1-1		7	12'		1	SEE NOTE 5
	•			TOTAL		13	4	_

### ROADSIDE SIGN PANEL QUANTITIES

					BACKGROU	ND	LEGEND		PROTECTIVE OVERLAY	
SIGN CODE	No. OF SIGNS	SIGN MESSAGE/ DESCRIPTION	PANEL SIZE (W X H)	PANEL AREA	SHEETING COLOR	RETROREFLECTIVE ASTM TYPE	SHEETING COLOR	RETROREFLECTIVE ASTM TYPE	PREMIUM	FURNISH SINGLE SHEET ALUMINUM SIGN UNFRAMED 0.063"
			INCHES	SF		ETR STA		ETR STA		THICKNESS SF
SW50-1P (CA)	1	SENIOR ZONE	24 X 18	3.00	YELLOW	XI	BLACK		X	3.00
R3-7 (R)	1	RIGHT LANE MUST TURN RIGHT	30 X 30	6.25	WHITE	IX	BLACK		X	6.25
R4-4	1	BEGIN RIGHT TURN LANE YIELD TO BIKES	36 X 30	7.50	WHITE	IX	BLACK		X	7.50
R4-11	1	BICYCLES MAY USE FULL LANE	30 X 30	6.25	WHITE	IX	BLACK		X	6.25
R5-1	2	DO NOT ENTER	30 X 30	6.25	WHITE	IX	RED	ΧI	X	12.50
R81B (CA)	1	END	8 X 5	0.28	WHITE	IX	BLACK	\ \ \ \ \ \ \ \ \ \ \ \ \ \ \ \ \ \ \	X	0.28
R81A (CA)	1	BEGIN	12 X 5	0.42	WHITE	IX	BLACK		X	0.42
* *	5			0.67	WHITE	IX			X	
R81 (CA)		BIKE LANE	12 X 8			1	BLACK			3.33
R10-6	2	STOP HERE ON RED	24 X 36	6.00	WHITE	IX	BLACK		X	12.00

WOOD RODGERS
BUILDING RELATIONSHIPS ONE PROJECT AT A TIME 3301 C ST, BLDG. 100-B TEL 916.341.7760 SACRAMENTO, CA 95816 FAX 916.341.7767 SEBASTOPOL

PUBLIC WORKS DEPARTMENT CITY OF SEBASTOPOL

DATE: AUG 2025
DRAWN BY: MR DESIGNED BY: KA
CHECKED BY: SR
APPROVED BY: SR CALIFORNIA

PPROVED BY:	No.	REVISION	DATE	BY
ATE: SEPTEMBER 29, 2025				
" origination				
ARIO LANDROS, INTERIM CITY ENGINEER				


HORIZONTAL COORDINATES ARE BASED ON CALIFORNIA STATE PLANE ZONE 3 UTILIZING THE CALIFORNIA SURVEYING AND DRAFTING SUPPLY REAL-TIME GPS NETWORK. DATA WAS COLLECTED IN MARCH 2021.

HELD POINT 102 (N:1907913.15, E:6321132.81 E:226.65)(WR PT#102) FOR SCALE FACTOR OF 1.00001999260. DISTANCES AND COORDINATES ARE GROUND. DATA WAS COLLECTED IN MAY 2021.


**BENCHMARK** 

THE BENCHMARK FOR THIS SURVEY IS A METAL ROD IN A WELL AT THE INTERSECTION OF BODEGA AVENUE AND PLEASENT HILL AVENUE NORTH, 87.9 FT NORTH OF THE CENTER OF BODEGA AVENUE 22.6 FT NORTHEAST OF THE CENTERLINE OF PLEASENT HILL AVENUE, 10.2 FT NORTH-NORTHWEST OF A FIRE HYDRANT BETWEEN POWER POLE SM25695 THE CURB OF PLEASANT HILL AVE NORTH.

MON ID: JT9460 DATUM: NAVD88 223.15' **ELEVATION:** 

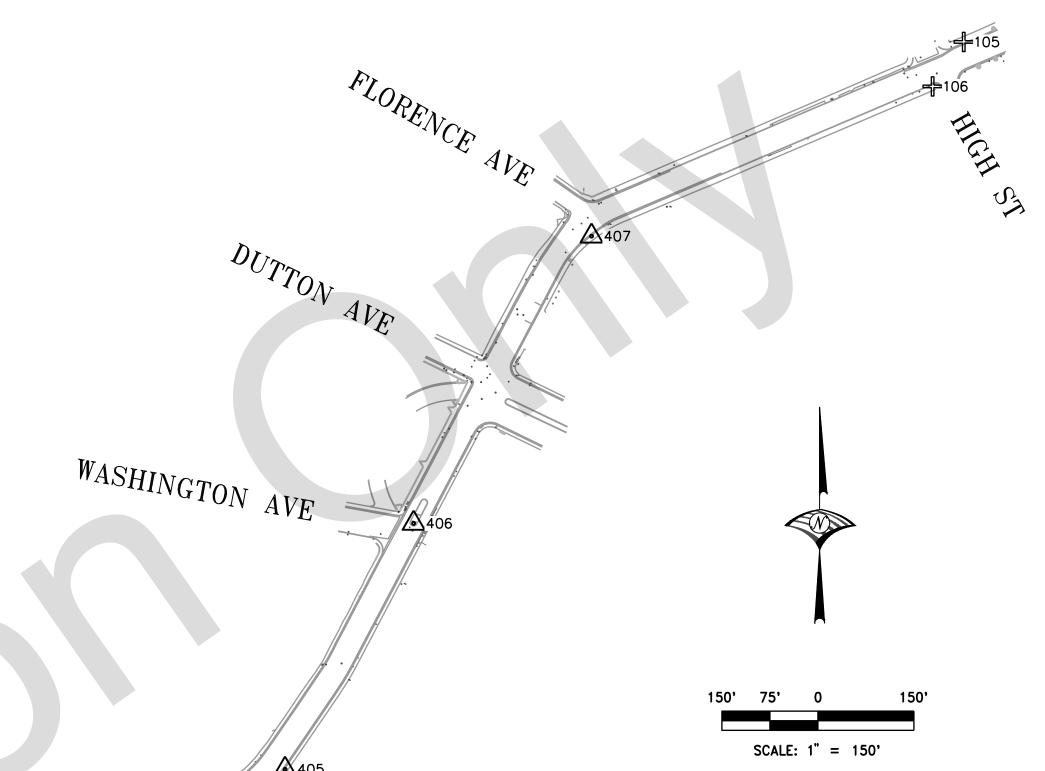

PERSONAL HILL WAS
<b>A</b>
1014 603 501
· • • • • • • • • • • • • • • • • • • •

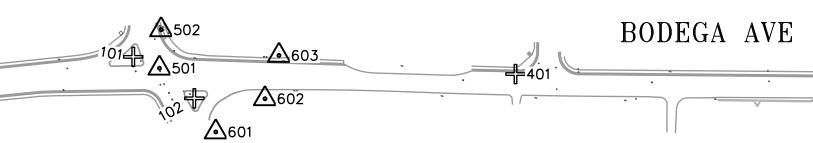

. 403

			Point Tabl	е
Pt#	Elev	Northing	Easting	Description
403	183.60	1907923.35	6322698.02	CUT X IN ISLAND
404	139.30	1907932.79	6323842.77	CUT X IN TC
405	127.84	1908063.12	6324052.54	SET 1IN BD LS9177 IN WALK
406	113.07	1908447.28	6324253.48	SET 1IN BD LS9177 IN NOSE
407	110.48	1908896.02	6324531.42	SET 1IN BD LS9177 IN WALK
501	223.88	1907960.10	6321078.39	FD 2IN BD IN WELL (ILLEGABLE)
502	223.15	1908020.14	6321080.94	TBM JT9460

	Point Table						
Pt#	Elev	Northing	Easting	Description			
551	232.59	1906825.44	6322247.36	FD 2" BD LS3890 (NO PUNCH)			
552	240.66	1906689.93	6322188.34	FD 2" BD LS3890 (NO PUNCH)			
601	224.82	1907860.54	6321166.31	FD. 1001 1/2IP BRUNNER LS4206			
602	226.92	1907912.38	6321243.19	FD. 1004 1/2IP LS3890			
603	229.57	1907980.13	6321265.13	FD. 1005 1/2IP DONMON LS5132			

			Point Table	
Pt#	Elev	Northing	Easting	Description
101	224.26	1907977.87	6321037.43	CUT X IN ISLAND W/ORG FX
102	226.65	1907913.15	6321132.81	CUT X IN ISLAND W/ORG FX
103	151.00	1907941.70	6323471.61	CUT X IN VALLEY GUT FX
104	153.19	1907900.88	6323400.24	CUT X IN WALK FX
105	101.55	1909199.44	6325112.96	CUT X IN WALK FX
106	103.65	1909129.93	6325064.41	CUT X IN WALK FX
401	236.28	1907950.97	6321634.75	CUT X IN ISLAND W/ORG FX
402	216.96	1907948.90	6322153.89	SET 1IN BD LS9177 IN TC


WOOD RODGERS BUILDING RELATIONSHIPS ONE PROJECT AT A TIME	
3301 C St, Bldg. 100-B Tel 916.341.7760 Sacramento, CA 95816 Fax 916.341.7767	

PUBLIC WORKS DEPARTMENT

OF SEBASTOPOL CALIFORNIA SEBASTOPOL

DATE: AUG 2025
DRAWN BY: MR DESIGNED BY: KA CHECKED BY: SR APPROVED BY: SR SCALE: AS SHOWN

DATE AUGUST 1, 2025

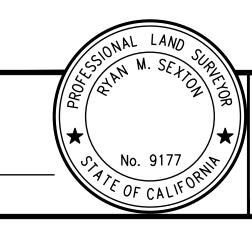

550 | 226.66 | 1906981.58 | 6322230.98

APPROVED BY: DATE: <u>SEPTEMBER 29</u> , 2025
maniforder
MARIO LANDROS, INTERIM CITY ENGINEER CITY OF SEBASTOPOL

RD

FD 2"BD LS3890 (NO PUNCH)

No.	REVISION	DATE	BY	

BODEGA AVENUE BIKE LANES AND REHABILITATION PHASE 2 PROJECT CONTROL

