
## GENERAL NOTES: (APPLIES TO ALL SHEETS)

- 1. ALL MATERIAL, WORKMANSHIP, AND CONSTRUCTION SHALL CONFORM TO THE CITY OF SEBASTOPOL 2021 STREET STANDARDS, THE 2023 CALTRANS STANDARD PLANS (CSP) AND SPECIFICATIONS, AND THE 2014 CALIFORNIA MANUAL ON UNIFORM TRAFFIC CONTROL DEVICES (CA-MUTCD) LATEST REVISION.
- 2. WORK HOURS ARE LIMITED TO MONDAY THROUGH FRIDAY, 7:00 AM. TO 5:30 P.M. INSPECTION WILL BE AVAILABLE MONDAY THROUGH FRIDAY FROM 8:00 AM. TO 4:00 P.M. CONTRACTORS SHALL SCHEDULE INSPECTIONS 48 HOURS IN ADVANCE.
- 3. ANY DISCREPANCY DISCOVERED BY CONTRACTOR IN THESE PLANS OR ANY FIELD CONDITIONS DISCOVERED BY CONTRACTOR THAT MAY DELAY OR OBSTRUCT THE PROPER COMPLETION OF THE WORK PER THESE PLANS SHALL BE BROUGHT TO THE ATTENTION OF THE CITY ENGINEER IMMEDIATELY UPON DISCOVERY. NOTIFICATION SHALL BE IN WRITING
- 4. DURING CONSTRUCTION, THE CONTRACTOR SHALL BE RESPONSIBLE FOR CONTROLLING NOISE, ODORS, DUST AND DEBRIS TO MINIMIZE IMPACTS ON SURROUNDING PROPERTIES AND ROADWAYS. CONTRACTOR SHALL BE RESPONSIBLE TO ASSURE THAT ALL CONSTRUCTION EQUIPMENT IS EQUIPPED WITH MANUFACTURERS APPROVED MUFFLER'S AND BAFFLES. FAILURE TO COMPLY MAY RESULT IN THE ISSUANCE OF A STOP WORK ORDER.
- 5. IF HAZARDOUS MATERIALS ARE ENCOUNTERED DURING CONSTRUCTION, THE CONTRACTOR SHALL HALT CONSTRUCTION IMMEDIATELY, NOTIFY THE CITY ENGINEER, AND IMPLEMENT REMEDIATION AS DIRECTED BY THE CITY OR ITS AGENTS.
- 6. PRIOR TO CONSTRUCTION, THE CONTRACTOR SHALL SUBMIT A TRAFFIC CONTROL PLAN FOR APPROVAL BY CITY STAFF THAT COMPLIES WITH THE CA-MUTCD.
- 7. THE CONTRACTOR SHALL BE REQUIRED TO MAINTAIN TRAFFIC FLOW ON AFFECTED ROADWAYS DURING NON—WORKING HOURS, AND TO MINIMIZE TRAFFIC RESTRICTION DURING CONSTRUCTION. NO EXISTING STREET SHALL BE ALLOWED TO BE COMPLETELY CLOSED WITHOUT THE EXPRESSED WRITTEN PERMISSION OF THE CITY ENGINEER. ACCESS TO ALL PROPERTIES SHALL BE MAINTAINED THROUGH CONSTRUCTION.
- 8. ALL EXISTING OR PROPOSED OVERHEAD AND UNDERGROUND UTILITIES SHALL BE PROTECTED THROUGHOUT THE CONSTRUCTION OF THE PROJECT IMPROVEMENTS.

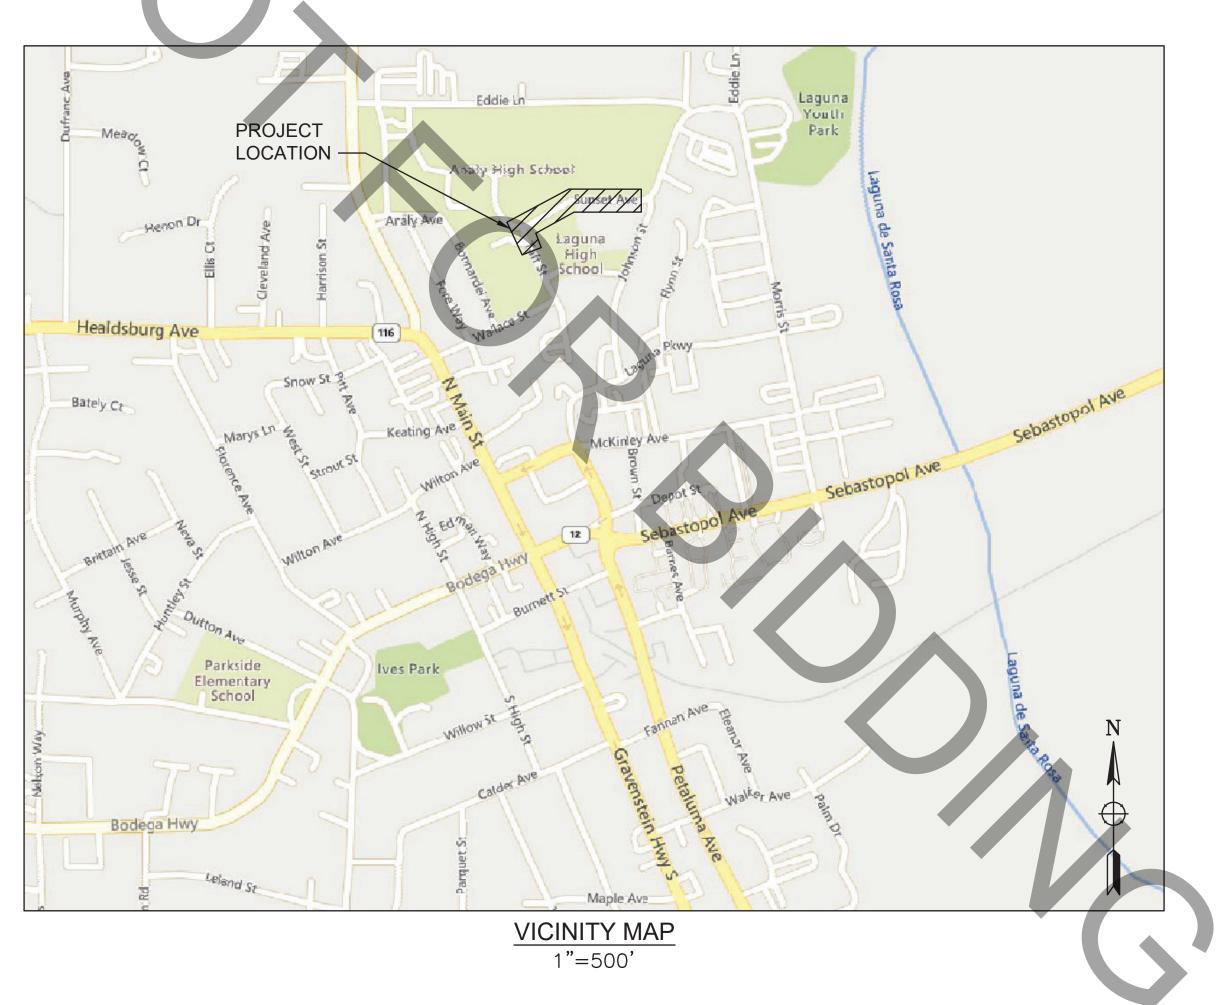

## SHEET INDEX

	Т
DESCRIPTION	SHEET NO
TITLE SHEET	1
SIGNING & STRIPING PLAN	2
PAWB ASSEMBLY DETAILS	3
CURB RAMP SITE PLAN	4
CURB RAMP GRADING PLAN	5

SUNSET AVE/TAFT ST PEDESTRIAN CROSSING IMPROVEMENTS

SUNSET AVE AT TAFT ST, ANALY HIGH SCHOOL

SUNSET AVE AT TAFT ST, ANALY HIGH SCHOOL

SEBASTOPOL, CA

STANLLINE SHEET

DIGALERT

UNDERGROUND SERVICE ALERT

DIAL TOLL FREE
1-800-227-2600
OR 811
AT LEAST TWO WORKING DAYS
BEFORE DIGGING

PLANS APPROVED BY:

Date Revision By SCALE AS NOTED

DATE 2/27/24

JOB NO.

SEB910

DATE 1/27/24

JORAWING NUMBER

MARIO LANDEROS, CITY ENGINEER
CITY OF SEBASTOPOL

Date Revision By AS NOTED

DATE

1 OF 5

N:\AAA\SOX\SEB\910SEB Analy High School Crosswalks Design\ACAD\SEB910—E.dwg

eb 28, 2024 – 10:14a

SCALE: 1"=40'

SCALE 1"=40' Revision DATE 2/27/24 SEB910 DRAWING NUMBER 2 of 5

GENERAL NOTES (APPLIES TO SHEETS 2 AND 3): 1. WORK SHOWN ON THIS SHEET IS ACCURATE FOR PEDESTRIAN ACTIVATED WARNING BEACON (PAWB), SIGNING, AND STRIPING WORK ONLY.

2. ALL MATERIAL, WORKMANSHIP, AND CONSTRUCTION SHALL CONFORM TO THE CITY OF SEBASTOPOL STREET STANDARDS, THE 2023 CALTRANS STANDARD PLANS (CSP) AND SPECIFICATIONS, AND THE 2014 CALIFORNIA MANUAL ON UNIFORM TRAFFIC CONTROL DEVICES (CA-MUTCD) LATEST REVISION.

- 3. CONTRACTOR SHALL CALL U.S.A. AT 811 OR 1-800-642-2444 AND HAVE UTILITIES MARKED AT LEAST TWO WORKING DAYS BEFORE BEGINNING ANY
- 4. CONTRACTOR SHALL AVOID DAMAGING ALL EXISTING FACILITIES, NOT SHOWN FOR REMOVAL ON THESE PLANS. FACILITIES SHALL BE REPAIRED BY THE CONTRACTOR AT HIS/HER EXPENSE.
- 5. CONTRACTOR SHALL MARK POLE LOCATIONS AND HAVE THEM VERIFIED BY THE CITY ENGINEER PRIOR TO INSTALLATION.
- 6. CONTRACTOR SHALL VERIFY OVERHEAD CLEARANCE WITH UTILITY COMPANIES PRIOR TO CONSTRUCTION.
- 7. CONTRACTOR SHALL PROVIDE ALL EQUIPMENT NECESSARY FOR COMPLETE SOLAR POWERED PAWB OPERATING SYSTEM.
- 8. THE PUSH BUTTON SHALL BE THE AUDIBLE TYPE CONFORMING TO CALTRANS ADA REQUIREMENTS, POLARA BULLDOG MODEL OR APPROVED EQUAL.
- 9. PAWB SHALL BE THE TAPCO BLINKERBEACON OR APPROVED EQUAL. PAWB SYSTEM SHALL OPERATE ON SOLAR POWER WITH BATTERY.
- 10. LIGHTED PEDESTRIAN CROSSING SIGNS SHALL BE THE TAPCO BLINKERSIGN 36"X36" OR APPROVED EQUAL. SYSTEM SHALL OPERATE ON SOLAR POWER WITH BATTERY.
- 11. CONTROLLER SHALL BE TAPCO OR APPROVED EQUAL AND OPERATE ON SOLAR POWER WITH BATTERY.

12. ALL PAVEMENT MARKINGS AND STRIPING ARE TO BE THERMOPLASTIC, UNLESS

- OTHERWISE NOTED ON PLANS.
- 13. ALL EXISTING STRIPING AND MARKINGS TO BE REMOVED SHALL BE REMOVED BY GRINDING BY THE CONTRACTOR.
- 14. CONTRACTOR SHALL BE RESPONSIBLE FOR LAYOUT AND CAT TRACKING OF ALL NEW INSTALLATION OF STRIPING AND MARKINGS. CAT TRACKING SHALL BE DONE A MINIMUM OF 48 HOURS PRIOR TO PROPOSED INSTALLATION TO ALLOW CITY STAFF TIME FOR REVIEW AND APPROVAL.
- 15. SIGNING AND STRIPING WORK SHALL BE COMPLETED CONCURRENTLY.

QUANTITY

NEW STRIPING

NEW CONDUIT

LEGEND:

NEW SIGN OR RRFB ASSEMBLY

EXISTING SIGN

NEW STRIPING DETAIL PER CSP

A20A TO A20D NEW SIGN LETTER DESIGNATION. SEE SIGN TABLE

R1 - 5

## SIGN LEGEND:




W16-9P





W16-7P

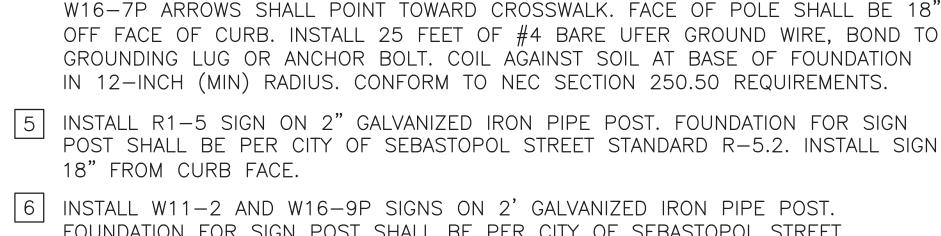

- FOUNDATION FOR SIGN POST SHALL BE PER CITY OF SEBASTOPOL STREET STANDARD R-5.2. INSTALL SIGN 18" FROM CURB FACE.
- REMOVE EXISTING CROSSWALK MARKINGS.

~(27B) 200 LF

CUSTOM "PASSENGER LOADING"

**QUANTITY** 

102 LF

460 LF

235 SF

27 SF

PR SIGN, R81A (CA), CUSTON

CUSTOM "NO STOPPING" SIGN,

**DETAIL** 

DETAIL 22

DETAIL 27B

YELLOW CROSSWALK

WHITE YIELD LINES

R81B (CA)

PR CUSTOM "PASSENGER LOADING" SIGN,

NEW STRIPING QUANTITIES

"ENFORCED 24 HOURS"

[21']

(27B) 180 LF

NEW SIGNING QUANTITIES

**SIGN** 

W11-2 (BLINKER)

W11-2

W16-7P(R)

W16-7P(L)

W16-9P

R1-5

PROJECT NOTES (THIS SHEET ONLY):

PR PROTECT IN PLACE EXISTING SIGN AND POST

RS REMOVE AND SALVAGE EXISTING SIGN AND POST

60 LF (27B)

PAWB ASSEMBLY

QUANTITIES

COMPONENT

ROUND FLASHERS

APS

CONTROLLER

**SOLAR PANEL** 

TYPE I-B POLE

20 LF (27B)

QUANTITY

2

1 INSTALL 11' WIDE YELLOW LADDER CROSSWALK PER CALTRANS STD PLAN NO A24F

INSTALL PAWB ASSEMBLY WITH CONTROLLER, SOLAR PANEL, FLASHING SIGNS, AN

BEACONS ON ONE SIDE OF 15' TALL TYPE 1-B POLE. SEE DETAIL A, SHEET 3

CROSSWALK. INSTALL 25 FEET OF #4 BARE UFER GROUND WIRE, BOND TO

W16-7P ARROWS SHALL POINT TOWARD CROSSWALK. FACE OF POLE SHALL BE 18 OFF FACE OF CURB. APS SHALL BE INSTALLED WITH BUTTON FACE PARALLEL TO

GROUNDING LUG OR ANCHOR BOLT. COIL AGAINST SOIL AT BASE OF FOUNDATION

IN 12-INCH (MIN) RADIUS. CONFORM TO NEC SECTION 250.50 REQUIREMENTS.

BEACONS ON ONE SIDE OF 15' TALL TYPE 1-B POLE. SEE DETAIL B, SHEET 3.

4 INSTALL PAWB ASSEMBLY WITH CONTROLLER, SOLAR PANEL, FLASHING SIGNS, AND

2 INSTALL YIELD LINE PAVEMENT MARKING PER CALTRANS STD PLAN NO A24G.

REMOVE EXISTING RAISED CENTERLINE PAVEMENT MARKERS.

CUSTOM "NO PR-

RS W11-2, W16-7P 3

235 SF 1

- TRIM VEGETATION

- SEE INSET A

60 LF (22)

W11-2, RS W16-7P

**INSET A:** 

1"=10'

FOR REDUCED PLANS, THE 0 1 2 3 ORIGINAL SCALE IS IN INCHES

N:\AAA\SOX\SEB\910SEB Analy High School Crosswalks Design\ACAD\SEB910-E.dwg

